ZONING BOARD OF APPEALS APPLICATION

.

Project Name, If Applicable:	ER ADDITION		
Project Street Address: <u>2 NORTHWAY, VIL</u>	LAGE OF BRONXVILL	<u>E, NY</u>	<u>.</u>
Section: Block: _2 Lot	(s): <u>2, 4 & 5</u>	Zone:	<u>4A</u>
Applicant: Arthur Lange, Inc.		·····	
Address: PO Box 993		A	
City: Bronxville	State: <u>NY</u>	Zip:10708	
Phone #: 914-337-4422	Email: lang	geartc@aol.com	
Owner:Carla Gallo			
Address: 2 Northway			
City: Bronxville	State: <u>NY</u>	Zip: 1 07 08	
Phone #: 914-337-4422		geartc@aol.com	
Application is for:			
An interpretation of the Zoning	Law or a determination b	y the Superintendent of Buildings	5
X Area variance(s) F.A R.			
Use Variance			
Special Permit Use		List Sections	
·		_ist Sections	
Description of the proposed project and na sought:_ <u>PROJECT IS AN ADDITTION /EX</u>	-	· · · ·	
WITH ADJECTENT PORCH. OWN			
THROUGH CREATING EXTENDE			
FROM HARSH WEATHER CONDI INDENT IN THE FACADE. THIS			
OF THE HOUSE, WHICH IS UNCO			

When did present owner acquire title?
Was the title acquired by purchase: (Yes or No), Ifso from whom?
Are you seeking a variance from the provisions of the ordinance? (Yes or No) NO
If so, from which ordinance, from which provision thereof and to what extent? NOT APPLICABLE
If you are seeking a variance from the provisions of the ordinance, do you contend that the effect of the ordinance on the property to which this appeal pertains is different from its effect on other properties in the same zoning district? (Yes or No) If so, in what respect and what is the cause of the difference?
NO
Does the owner of the premises involved in this application own any contiguous property? (Yes or
No) If so, in what respect and what is the cause of the difference? NO
Owners Signature: C. Gallo Date:

Zoning Compliance Analysis

Property Address: 2 NORTHWAY, VILLAGE OF BRONXVILLE, NEW YORK

Flood Zone: Yes: ____ No: ____

ZONING STANDARD	REQUIRED	EXISTING	PROPOSED	STATUS
BUILDING USE	SINGLE FAMILY	SINGLE FAMILY	SINGLE FAMILY	
LOT AREA	15,000 S.F	28,565.96 S.F	28,565.96 S.F.	
LOT WIDTH	100'	135'	135'	
LOT DEPTH	120	200'	200'	
FRONT YARD	35'	70.4'	70.4'	
SIDE YARD #1	301/151	40.1'	40.1'	
SIDE YARD #2				<u> </u>
REAR YARD	32'	41.5'	41.5'	
HEIGHT (Feet & Stories)	30'/2.5 STORIES	22'/2 STORIES	22'/2 STORIES	
BUILDING COVERAGE	22.5%	22.25%	22.33 %	
USABLE OPEN SPACE	55%	68.36%	65.41%	
F.A.R.	0.2275	0.2434	0.2587	
PARKING				

All applications for additions to submit complete detailed finished grade and FAR calculations, and completed F.A.R. computation worksheet on reverse, submission to be stamped by the design professional of record.

Are any variances required (or were any variances approved by the ZBA) that are not listed on the table above? <u>Yes</u> X No

If yes, describe all additional variances: ______

Form Prepared By:

Name (Print): DARIUSZ P. KULINSKI - ARCHITECT



Signature: _____ Darius P. Kulindi. _____

	Zoning F.A.I	R. Calculation	
	EXISTING	PROPOSED	SUB TOTAL
BASEMENT ^(b)	1,180.55	1,180.55	0.0
1 ST FLOOR	3,635.81	3,857.06	3,857.06
2 ND FLOOR	3,316.91	3,535.12	3,535.12
3 RD FLOOR ^(d)	N/A	N/A	N/A
ATTIC (d)	N/A	N/A	N/A
GARAGE (c)	490.2	490.2	90.2
AC	FUAL TOTAL BUILD	ING FLOOR AREA =	7,392.18
	AC	TUAL LOT AREA =	28,565.96
PERMITTED F.A	A.R. (From Table, inter	polate if necessary) =	0.2275
	ERMITTED BUILD LOT AREA X PEI	ING FLOOR AREA RMITTED F.A.R). =	6,498.75

Floor Area Ratio (for a lot whose principal use is a one or two family dwelling): The ratio of the gross floor area of all buildings on a lot to the area of the lot on which the buildings are located. For the purpose of determining the floor area ratio (FAR), all floor areas of each floor of all principal and all accessory structures on the lot shall be included. Any interior space with a floor-to-ceiling height in excess of 14 feet shall be counted twice. Notwithstanding the preceding the following shall be excluded from the calculation of floor area:

- a) The aggregate area of all unroofed structures such as decks and patios and all spaces in unenclosed porches and porticos, except that existing unenclosed porches may be enclosed and the enclosed area excluded from the FAR calculation provided that the exterior walls of the unenclosed porch and the walls of the dwelling to which the porch is attached are not relocated closer to the lot lines of the subject property than the existing unenclosed porch.
- b) The aggregate area of any cellar regardless of its use or of any basement unless it is defined as a story. See Basement definition.
- c) The aggregate area of grade level garage parking (whether attached or detached) or basement level parking, in either case, up to a maximum of 400 square feet. In those instances where an additional story is provided above a garage (whether attached or detached) such floor area shall be subject to the attic and sloping roof limitations in (d) below.
- d) The aggregate area of all unfinished or finished space in an attic or under a sloping roof provided that the total exterior width of all dormers does not exceed 30% of the exterior linear width of the portion of the roof upon which they are situated. The exterior linear width of the roof shall be measured from end to end at the widest point of the roof. Where the linear width of the dormers exceeds the limitation above, the total area in the attic or under the sloping roof shall be included in the calculation of FAR, except where floor area between the top of the floor beams and the structural ceiling level is five (5) feet or less.

Calculations Prepared By: Name (Print): DARIUSZ P. KULINSKI - ARCHITECT

Signature: ___ Dariese P. Kuliter



	Zon	ing F.A.R. Calculation	
	EXISTING	PROPOSED	SUB TOTAL
BASEMENT ^(b)	1,180.55	1,180.55	0.0
1 st FLOOR	3,635.81	3,857.06	3,857.06
2 ND FLOOR	3,316.92	3,535.12	3,535.12
3 RD FLOOR ^(d)	n/a	n/a	n/a
ATTIC ^(d)	n/a	n/a	n / a
GARAGE ^(c)	490.2	490.2	90.2
	ACTUAL TOTAL	BUILDING FLOOR AREA =	7,392.18
		ACTUAL LOT AREA =	28,565.96
F	PERMITTED F.A.R. (From Ta	able, interpolate if necessary) =	0.2275
	MAXIMUM PERM	IITTED BUILDING FLOOR AREA	
	(ACTUAL LOT /	AREA X PERMITTED F.A.R). =	6,498.75

***Please refer to the Village of Bronxville Municipal Code Section 310- 22 Supplementary Regulations.

Zoning Compliance Worksheet – District 'AA'

<u>Bronxville District 'AA'</u>	District	Height	Stories	Lot Area	Lot Width	Lot Depth	Front Yard	Side Yard with Garage	Side Yard without Garage	Side Yard corner lot with garage	Side Yard Corner Lot without garage	Side Yard w/ alternative with a garage	Rear Yard	Fence > than 6-1/2' H	ACC Building	Max Building coverage	Off street parking	FAR	Open space
Bronxville District 'AA' Description of Bulk Requirements	AA	30' mean Height	2-1/2	15000 sf	100'	120'	35'; alternative a) & b)	15'/ 35' min one side/ total 2 sides	27'/ 42' one side/ total 2 sides	30'/ 15' side opp primary front/ other side	30'/ 27' side opp primary front/ other side	deduct 5'	32'	Same as building	No closer than front of principal building, planning may issue special permit	22.5%	2 cars		55%
310-09 Code Section- https://ecode360.com/9450530		310-9B	310-9B	310- 9C	310- 9C	310- 9C	310-9D	310- 9D(2)	310- 9D(2)	310- 9D(2)	310- 9D(2)	310-9D(2)	310- 9D(3)	310- 9D(4)	310- 9D(5)	310-9E	310-9F	310- 9G; 310- 22E	310- 9H
Property Address:	2 NO	RTHWA	Y, BRON	IXVILLE	, NY														
Allowed	AA	30'	2.5 stories	15000 sf	100'	120'	35'	15'/ 35'	27'/ 42'	30'/ 15'	30'/ 27'		32'			22.5%	2 cars	0.2275	55%
Existing	AA	22'	2.0	28,565	135'	+/- 200'	70.4			40.1			41.5			22.25 %		0.2434	68.36%
Proposed	AA	22'	2.0	28,565	135'	+/- 200'	70.4			40.1			41.5			22.33 %		0.2587	65.41%
Variance required = (proposed - allowed)	N/A	N/A	N/A	N/A	N/A	N/A	N/A			N/A			N/A			N/A		0.0312 13.7 %	

VILLAGE OF BRONXVILLE Department of Buildings 200 Pondfield Road (914) 337-7338 (914) 337-0158 (Fax)

PLAN REVIEW COMMENTS

2 Northway

APPLICATION NUMB: ALT 093-21

DATE RECEIVED: May 17, 2021

LOCATION:

SBL: 7.A/2/4

APPLICANT NAME: Arthur Lange Inc.

APPLICANT ADDRESS: P.O. Box 993 Bronxville, NY 10708

DESCRIPTION OF WORK : Foyer addition.

DISAPPROVED July 16, 2021, FOR THE FOLLOWING:

Your revised application for a permit on the above location has been reviewed and a permit may not be issued at this time for the reasons indicated below.

ZONING CODE REVIEW (Section Numbers refer to Village Code of 1981)

Plan Review - ALT 093-21

Zoning -

1) Lot Size 28566 sf/ .66 acre

2) FAR Allowed -.2275/ (6540 sf); Existing FAR - .2464/ 7041sf; Proposed FAR - .2589/ 7392 sf; Increase in FAR - +351 sf/ .0125/ 5%;

3) Variance Required - .0125/ 893 sf

This document constitutes a final administrative determination by the Building Inspector denying your application for the reasons set forth above. Section 7-712(a) of the New York State Village Law provides that any appeal of this decision must be filed within 60 days of the date hereof with the Zoning Board of Appeals of the Village of Bronxville.

PLAN REVIEW

Plan Review Plan Review to be performed upon approval of Variance Request.

Paul Taft Building Inspector

AFFIDAVIT OF MAILING LEGAL NOTICE

I hereby swear that the following notice was given by certified mail or registered mail to the property owners listed below, at least ten (10) days prior to the hearing date:

Notice is hereby given that the Zoning Board of appeals of the Village of Bronxville will hold a public hearing at the Bronxville Village Hall, 200 Pondfield Road, Bronxville, N.Y., on Tuesday evening, September 28, 2021 at 6:30 P.M. to give consideration to the following appeals/variances:

The request of the Gallo Residence, property located at 2 Northway, Bronxville, New York, from a notice by the Building Inspector, for the following Section: Section 310-9(G) and 310-22 (E) -.00314/ 852 sf, Lot Size 28566 sf/ .66 acre, FAR Allowed -.2275/ (6540 sf); Existing FAR - .2464/ 7041sf; Proposed FAR - .2589/ 7392 sf; Increase in FAR - +351 sf/ .0125/ 5%.

All Zoning Applications can be found on our website www.villageofbronxville.com/zoning-boardof-appeals one week prior to the meeting.

(Applicant Signature)

(Applicant Print Name)

Sworn before me this $\underline{/3^{\mu}}$ day of $\underline{...}$ eptem



Summary Project Statement

Building Permits for exterior alterations/construction require a summary project statement.

Project Street Address: 2 NORTHWAY, BRONXVILLE, NY

Name: Carla Gallo

Address: 2 Northway, Bronxville NY

Telephone Number: 914-337-4422

Email of Applicant/Representative: <u>langeartc@aol.com, darkconn95@live.com</u>

Brief Summary of Work:

TWO STORIES FRONT FOYER ADDITION/ EXTENSION WITH NEW ROOF (18.0' WIDE AND 12.5' DEEP) AND NEW ADJECENT COVERED COLONNADE / PORCH (5.0' WIDE). NEW ADDITION FOOTPRINT IS 225 S.F AND NEW COVERED PORCH FOOTPRINT IS 400 S.F. NEW ADDITION NOT TO

EXCEED EXISTING HEIGHT OF THE HOUSE.

Attention: Publicly filed plans and relevant materials are available for inspection by prior appointment at the Building Department.

Directions to obtaining a list of neighbors within 100' radius of your property can be found on the Village of Bronxville's Building Department Page. Please visit <u>www.villageofbronxville.com/building</u>. In the left-hand column please click on Summary Project Statement and follow directions.


Please submit a copy of this form to the building department once completed. The applicant shall be required to provide a copy of the summary project statement to any property owner within 100 feet of the subject property by certified mail or registered mail within ten (10) days of submitting said building permit application or proposed plans for construction or demolition.


Signature) (Applicant Print Name)


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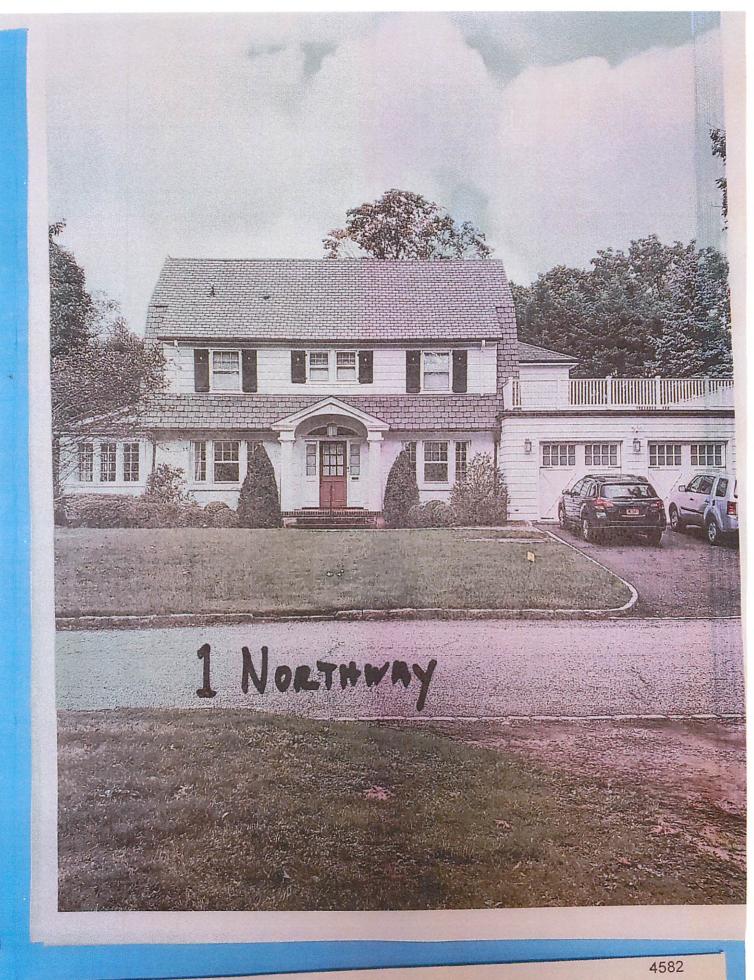


Notary Public




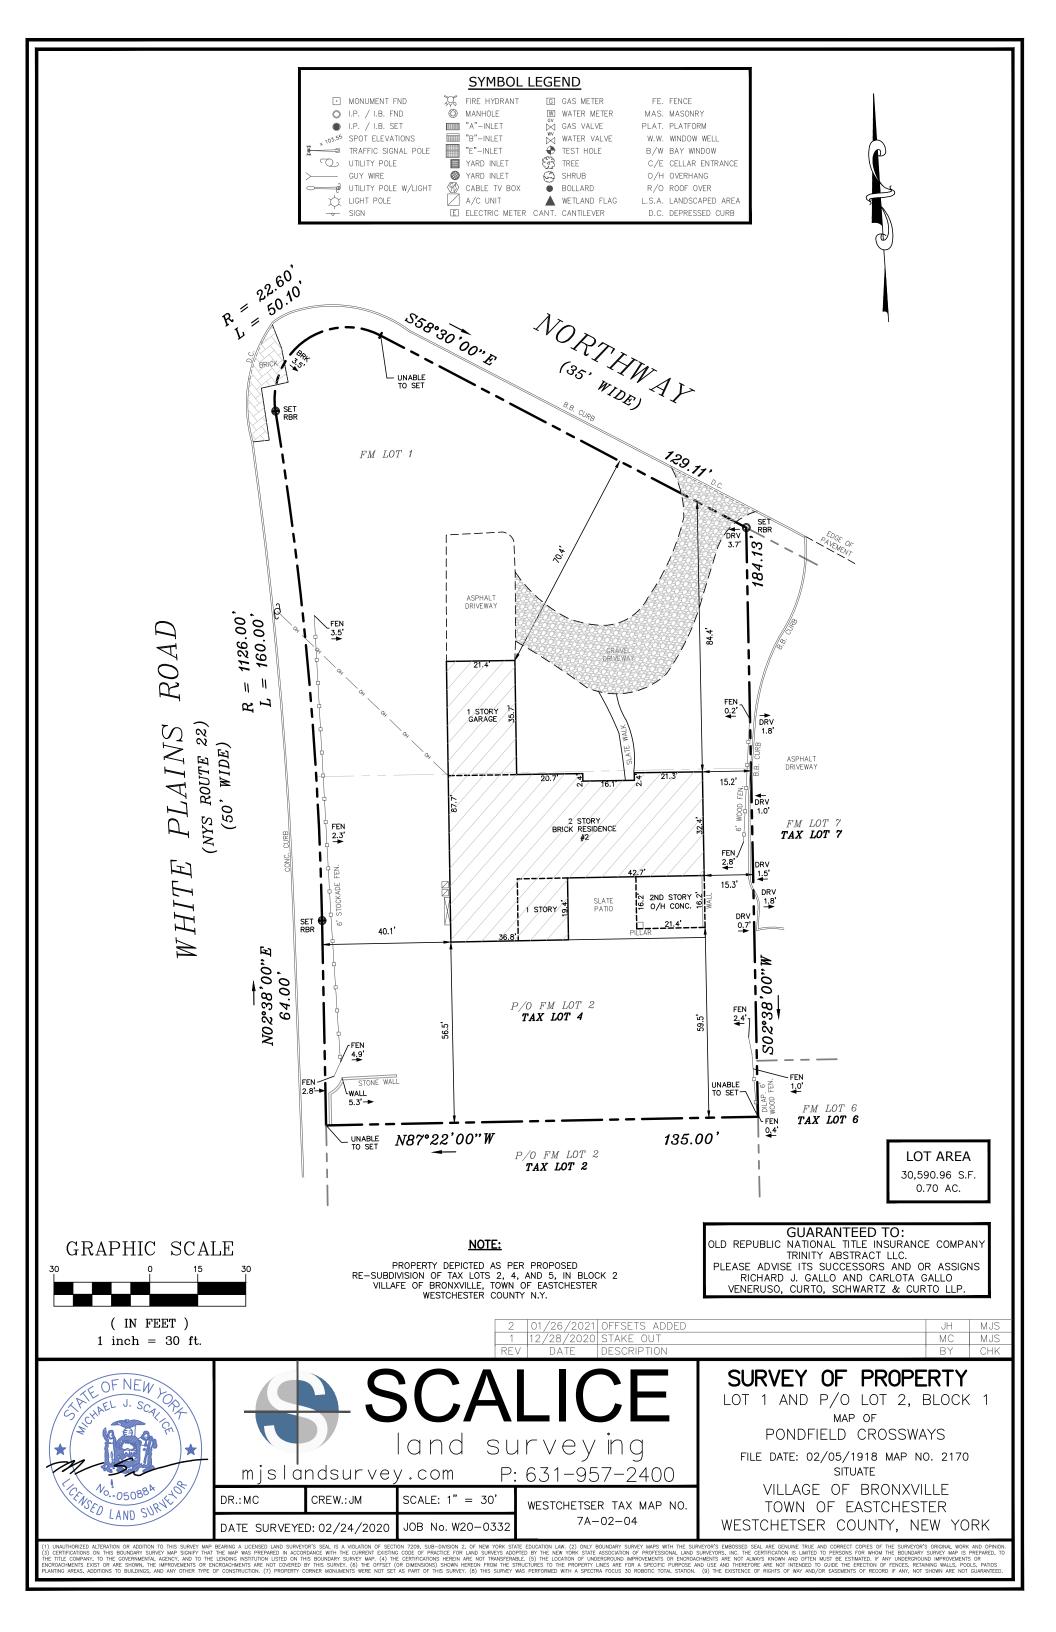


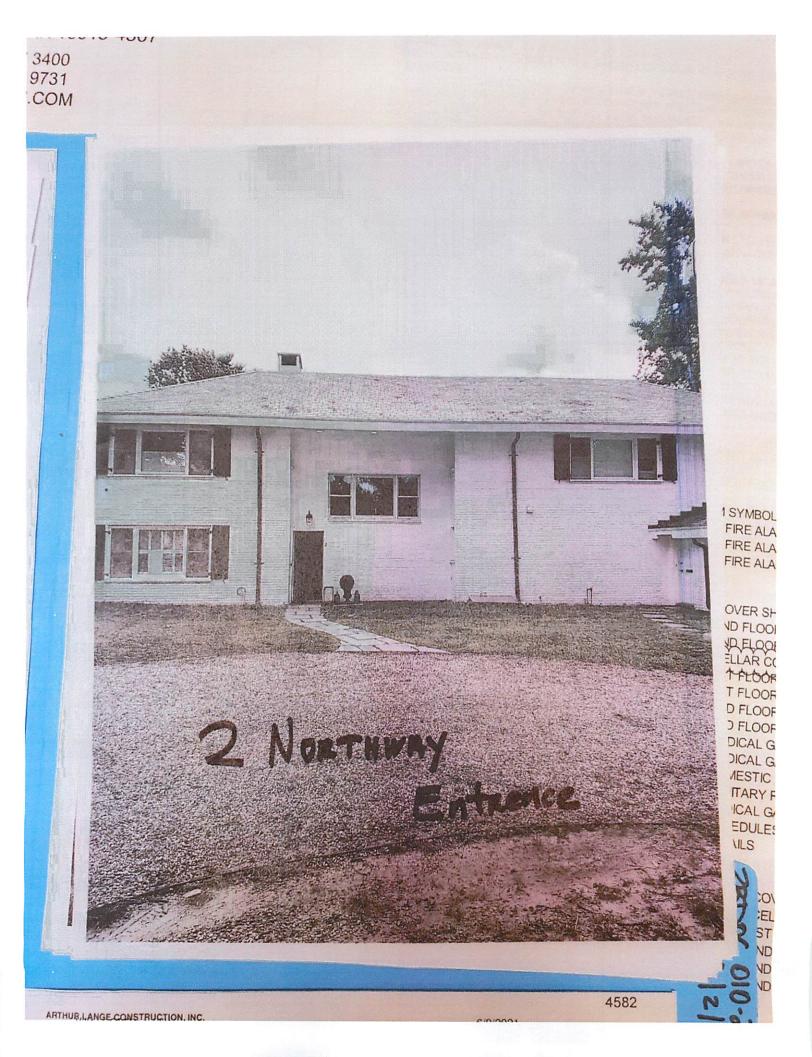

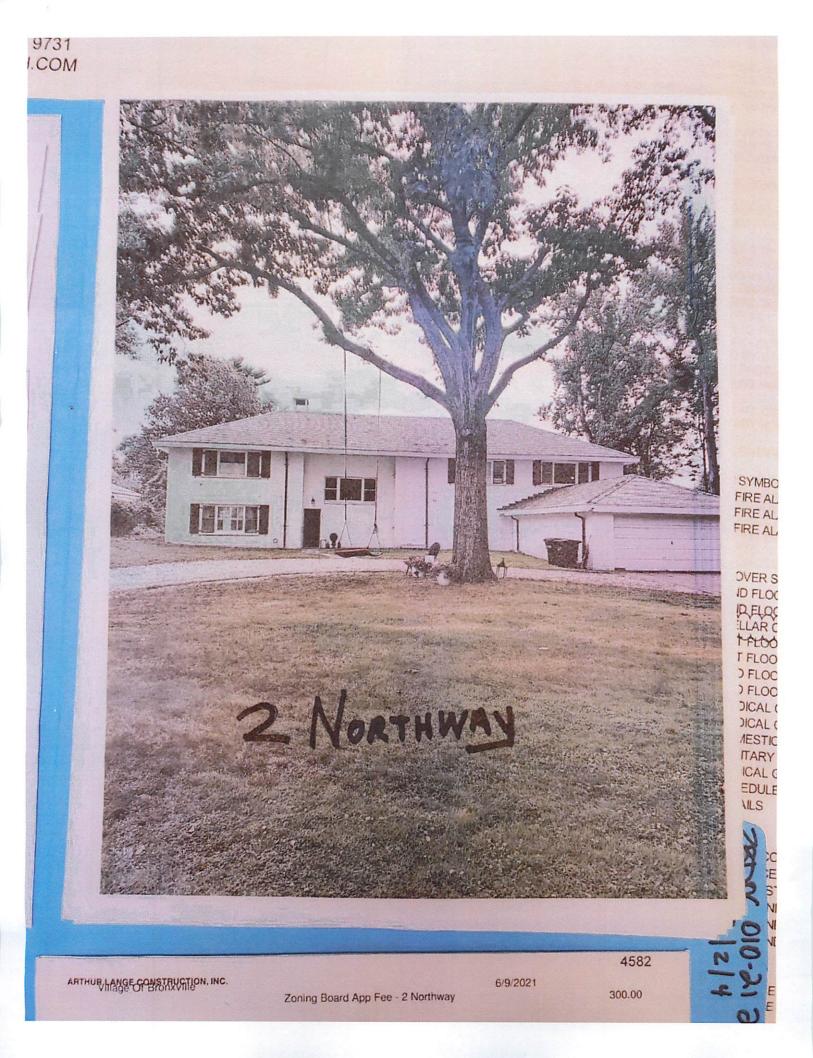

6/9/2021

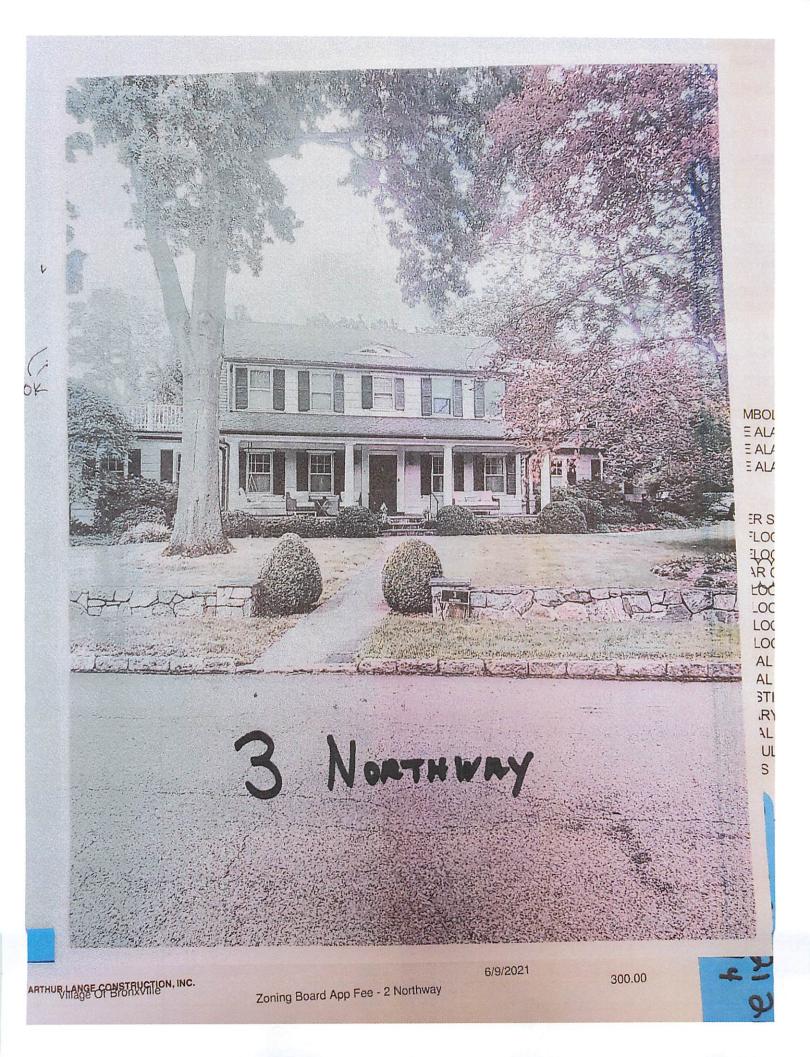

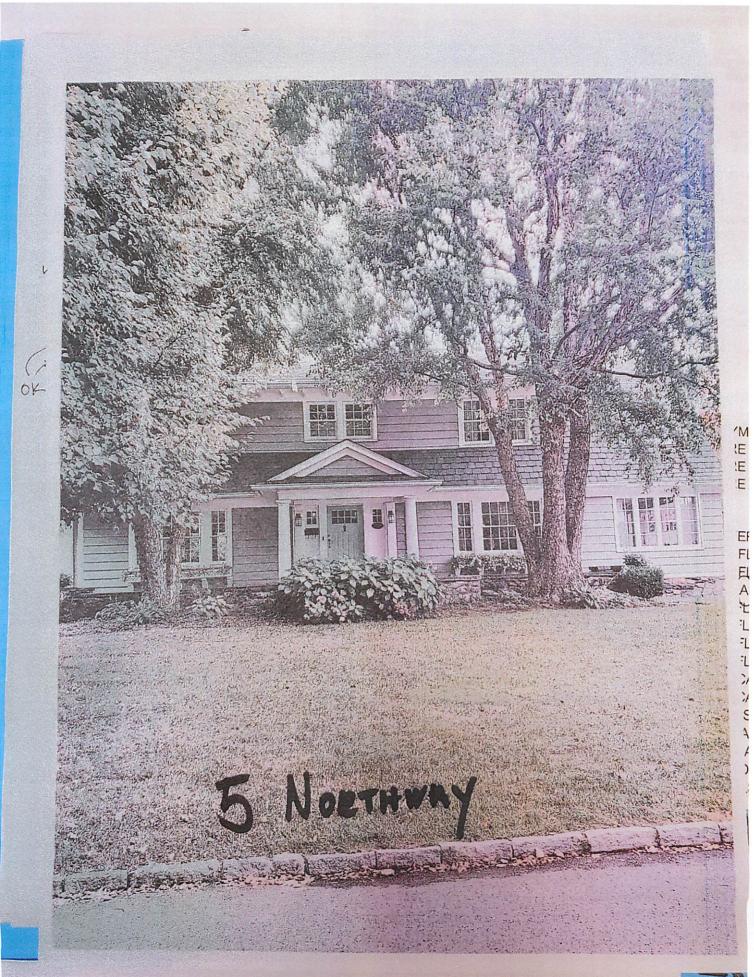

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All Zoning Applications can be found on our website <u>www.villageofbronxville.com/zoning-board-of-appeals</u> one week prior to the meeting.

hur C. Lange (Applicant Signature)

Hrthw (Applicant Print Name)

Sworn before me this 13th day of September 20 21

Notary Public



Village of Bronxville 200 Pondfield Road Bronxville, N.Y. (914) 337-7338

LEGAL NOTICE


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- The request of the Gonda & Keating Residence, property located at 21 Sunset Ave, Bronxville, New York, from a notice by the Building Inspector, for the following Section: Section 310-9 D(1) and 310-9 D(3) the following variance is required - Front Yard Required - 35'; 25' existing; 17.5' proposed; 17.5' Variance requested and rear Yard Required - 32'; 29.8' Existing; 20' proposed; 12' variance requested.
- The request of the Gallo Residence, property located at 2 Northway, Bronxville, New York, from a notice by the Building Inspector, for the following Section: Section 310-9(G) and 310-22 (E) - .00314/ 852 sf, Lot Size 28566 sf/ .66 acre, FAR Allowed -.2275/ (6540 sf); Existing FAR - .2464/ 7041sf; Proposed FAR - .2589/ 7392 sf; Increase in FAR - +351 sf/ .0125/ 5%.
- 3. The request of the Weber Residence, property located at 33 Elm Rock Rd, Bronxville, New York, from a notice by the Building Inspector, for the following Section: Section 310-22 (A) Obstruction to vision at street intersections. At all street intersections in all residence districts, no obstructions to vision (other than an existing building, post, column or tree) exceeding 30 inches in height above street level shall be erected or maintained on any lot within the triangle formed by the street lines cf such lot and a line drawn between points along such street lines 50 feet distant from their point of intersection.

All applications and links to our meetings can be found on our webpage www.villageofbronxville.com/zoning-board-of-appeals

Note: PLEASE HAVE THIS NOTICE APPEAR IN THE Friday, September 17, 2021 EDITION OF THE JOURNAL NEWS (SOUTHERN ZONE)

FRONT FOYER ADDITION TO

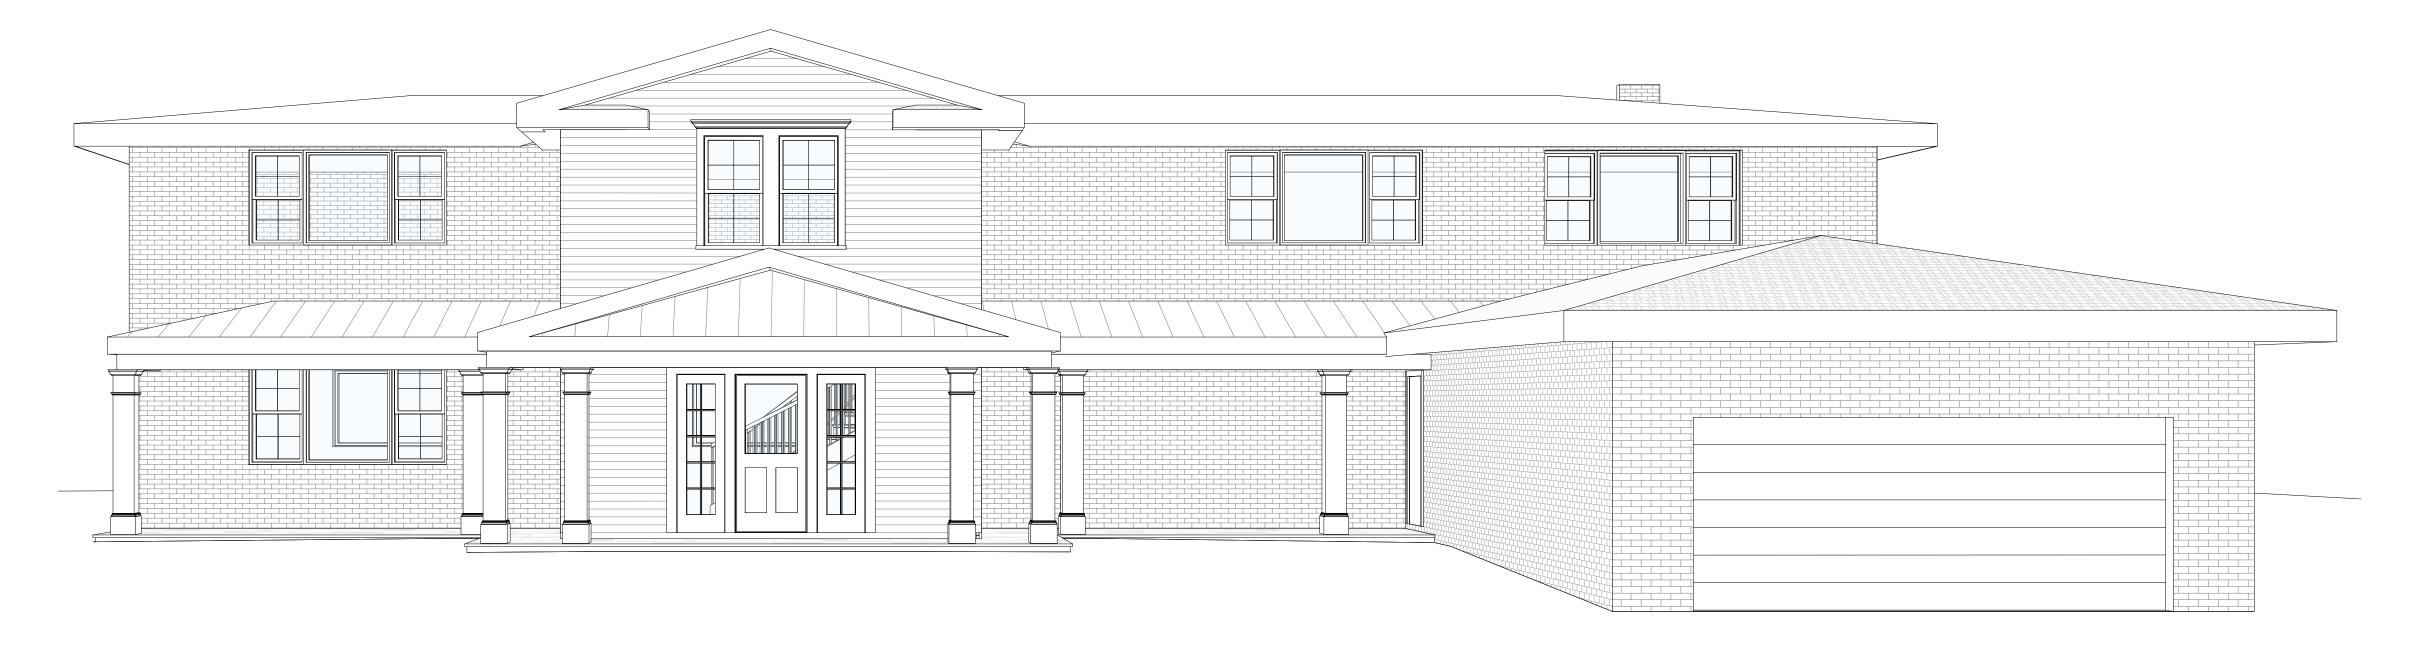

(1)<u>3D View</u> 1





2 Northway, BRONXVILLE, NY

ALL WORK AND MATERIALS SHALL CONFORM WITH ALL LOCAL CODES, ORDINANCES AND THE FOLLOWING AUTHORITIES:

- -RESIDENTIAL CODE OF NEW YORK STATE. -BUILDING CODE OF NEW YORK STATE.
- -ENERGY CONSERVATION CONSTRUCTION CODE OF NEW YORK STATE.
- -NATIONAL FIRE UNDERWRITER CODE. -PLUMBING, MECHANICAL AND FUEL GAS CODE OF NEW YORK STATE.
- -OCCUPATIONAL SAFETY & HEALTH ACT (O.S.H.A).
- -NATIONAL ELECTRIC CODE.
- -LOCAL CODES AND ORDINANCES. -2017 UNIFORM CODE SUPPLEMENT OF NEW YORK STATE.

2020 NYS RESIDENTIAL BUILDING CODE

TO THE BEST OF THE ARCHITECTS KNOWLEDGE THE DESIGN DESCRIBED IN THESE DRAWINGS IS IN COMPLIANCE WITH ALL REQUIREMENTS OF THE ENERGY CONSERVATION CONSTRUCTION CODE OF THE STATE OF NEW YORK.

CONTRACTOR TO INSTALL PROPER FIRE SEPARATION BETWEEN MECHANICAL EQUIPMENT ROOM AND PROPOSED HABITABLE SPACE. PROVIDE 3/4 HOUR FIRE RATED WALLS AND CEILING WITH 3/4 HOUR FIRE RATED SELF-CLOSING DOOR ASSEMBLY.

STAIR, RAIL, AND BALUSTERS SHALL CONFORM TO SECTION R314, R315, AND R3162 OF THE 2020 RESIDENTIAL CODE OF NEW YORK STATE. MIN OF 75 PERCENT OF LAMPS IN PERMANENTLY INSTALLED LIGHT FIXTURES ARE HIGH-EFFICIENCY LAMPS PER R404 OF THE 2020 ENERGY CONSERVATION CONSTRUCTION CODE OF NEW YORK

CONTRACTOR SHALL COMPLY WITH ALL 2020 RESIDENTIAL CODE OF NEW YORK STATE R314 REQUIREMENTS FOR PROPER INSTALLATION OF SMOKE DETECTORS/ ALARM - APPENDIX J. ALL SMOKE AND HEAT DETECTORS TO BE HARD-WIRED WITH BATTERY BACKUP AND INTERCONNECTED. SMOKE DETECTORS REQUIRED INSIDE ALL SLEEP ROOMS AND OUTSIDE ROOMS IN IMMEDIATE VICINITY OF SLEEP ROOMS. CONTRACTOR RESPONSIBLE FOR ALL REQUIRED DETECTORS WHETHER OR NOT SHOWN ON ELECTRICAL PLANS.

CONTRACTOR SHALL COMPLY WITH THE 2020 RESIDENTIAL CODE OF NEW YORK STATE SECTION R315 REQUIREMENT FOR PROPER INSTALLATION OF CARBON MONOXIDE DETECTORS/ ALARMS. CONTRACTOR IS RESPONSIBLE FOR ALL REQUIRED DETECTORS WHETHER OR NOT SHOWN ON ELECTRICAL PLANS.

CONTRACTOR SHALL COMPLY WITH THE 2020 RESIDENTIAL CODE OF NEW YORK STATE REQUIREMENTS FOR PROPER COMBUSTION AIR FOR MECHANICAL ROOM, PER SECTION M1701.1

KEYS

— DRAWING NUMBER - ELEVATION	
— DRAWING NUMBER - ELEVATION	
— DRAWING NUMBER - SECTION	D 000 -
	(W) -

FRONT FOYER ADDITION TO

2 Northway, BRONXVILLE, NY

DARIUSZ P. KULINSKI

ARCHITECT

1 BATES COURT, UNIT 401 NORWALK, CT 06854

T: 203 952 3037 E: DARKCONN95@LIVE.COM

CONNECTICUT - NEW YORK - CALIFORNIA

STRUCTURAL ENGINEER CARL E. RUSPINI, M.S., P.E.

414 PEPPER STREET MONROE, CT 06468 T: 203 410 9482

DESIGN NOTES:

ALL ELECTRICAL DESIGN BY GC

- ALL HVAC DESIGN BY GC
- ALL PLUMBING DESIGN BY GC

ABBREVIATIONS

ADJ. A.F.F.	ADJUSTABLE ABOVE FINISH FLOOR
	BOARD BOTTOM OF
CONC.	CLOSET CEILING CONCRETE COMPOSITION COVER
DIA. DN. DW	DIAMETER DOWN DISHWASHER
EA. ELEV. EQ. EXIST.	EACH ELEVATION EQUAL EXISTING
EXT.	EXTERIOR
FL. FIN. F.O. F.O.S. FOUND. FTG.	FIBERGLASS FLOOR FINISH FACE OF FACE OF STUD FOUNDATION FOOTING FIRE RATED
GYP.	GYPSUM
HDR. HT.	HEADER HEIGHT
I.D. INSUL.	INSIDE DIAMETER INSULATION
LDR	LEADER
	MAXIMUM MINIMUM MOULDING
NOM. NTS	NOMINAL NOT TO SCALE
OPNG.	OUTSIDE DIAMETER OPENING OPPOSITE
PLYWD. PT.	PLYWOOD POINT
Q.S.	QUARTER-SAWN
REINF. REQ'D. RM.	REFRIGERATOR REINFORCING/REINFORCED REQUIRED ROOM ROUGH OPENING
SIM.	SIMILAR
T.B.V. T.O.	TO BE DETERMINED TO BE VERIFIED TOP OF TYPICAL
U.N.O.	UNLESS NOTED OTHERWISE
V.I.F.	VERIFY IN FIELD
W/ WD.	WITH WOOD

W.I.C. WALK IN CLOSET

W/O WITHOUT

REV	DATE	ISSUE	
KEY			
PLAN			
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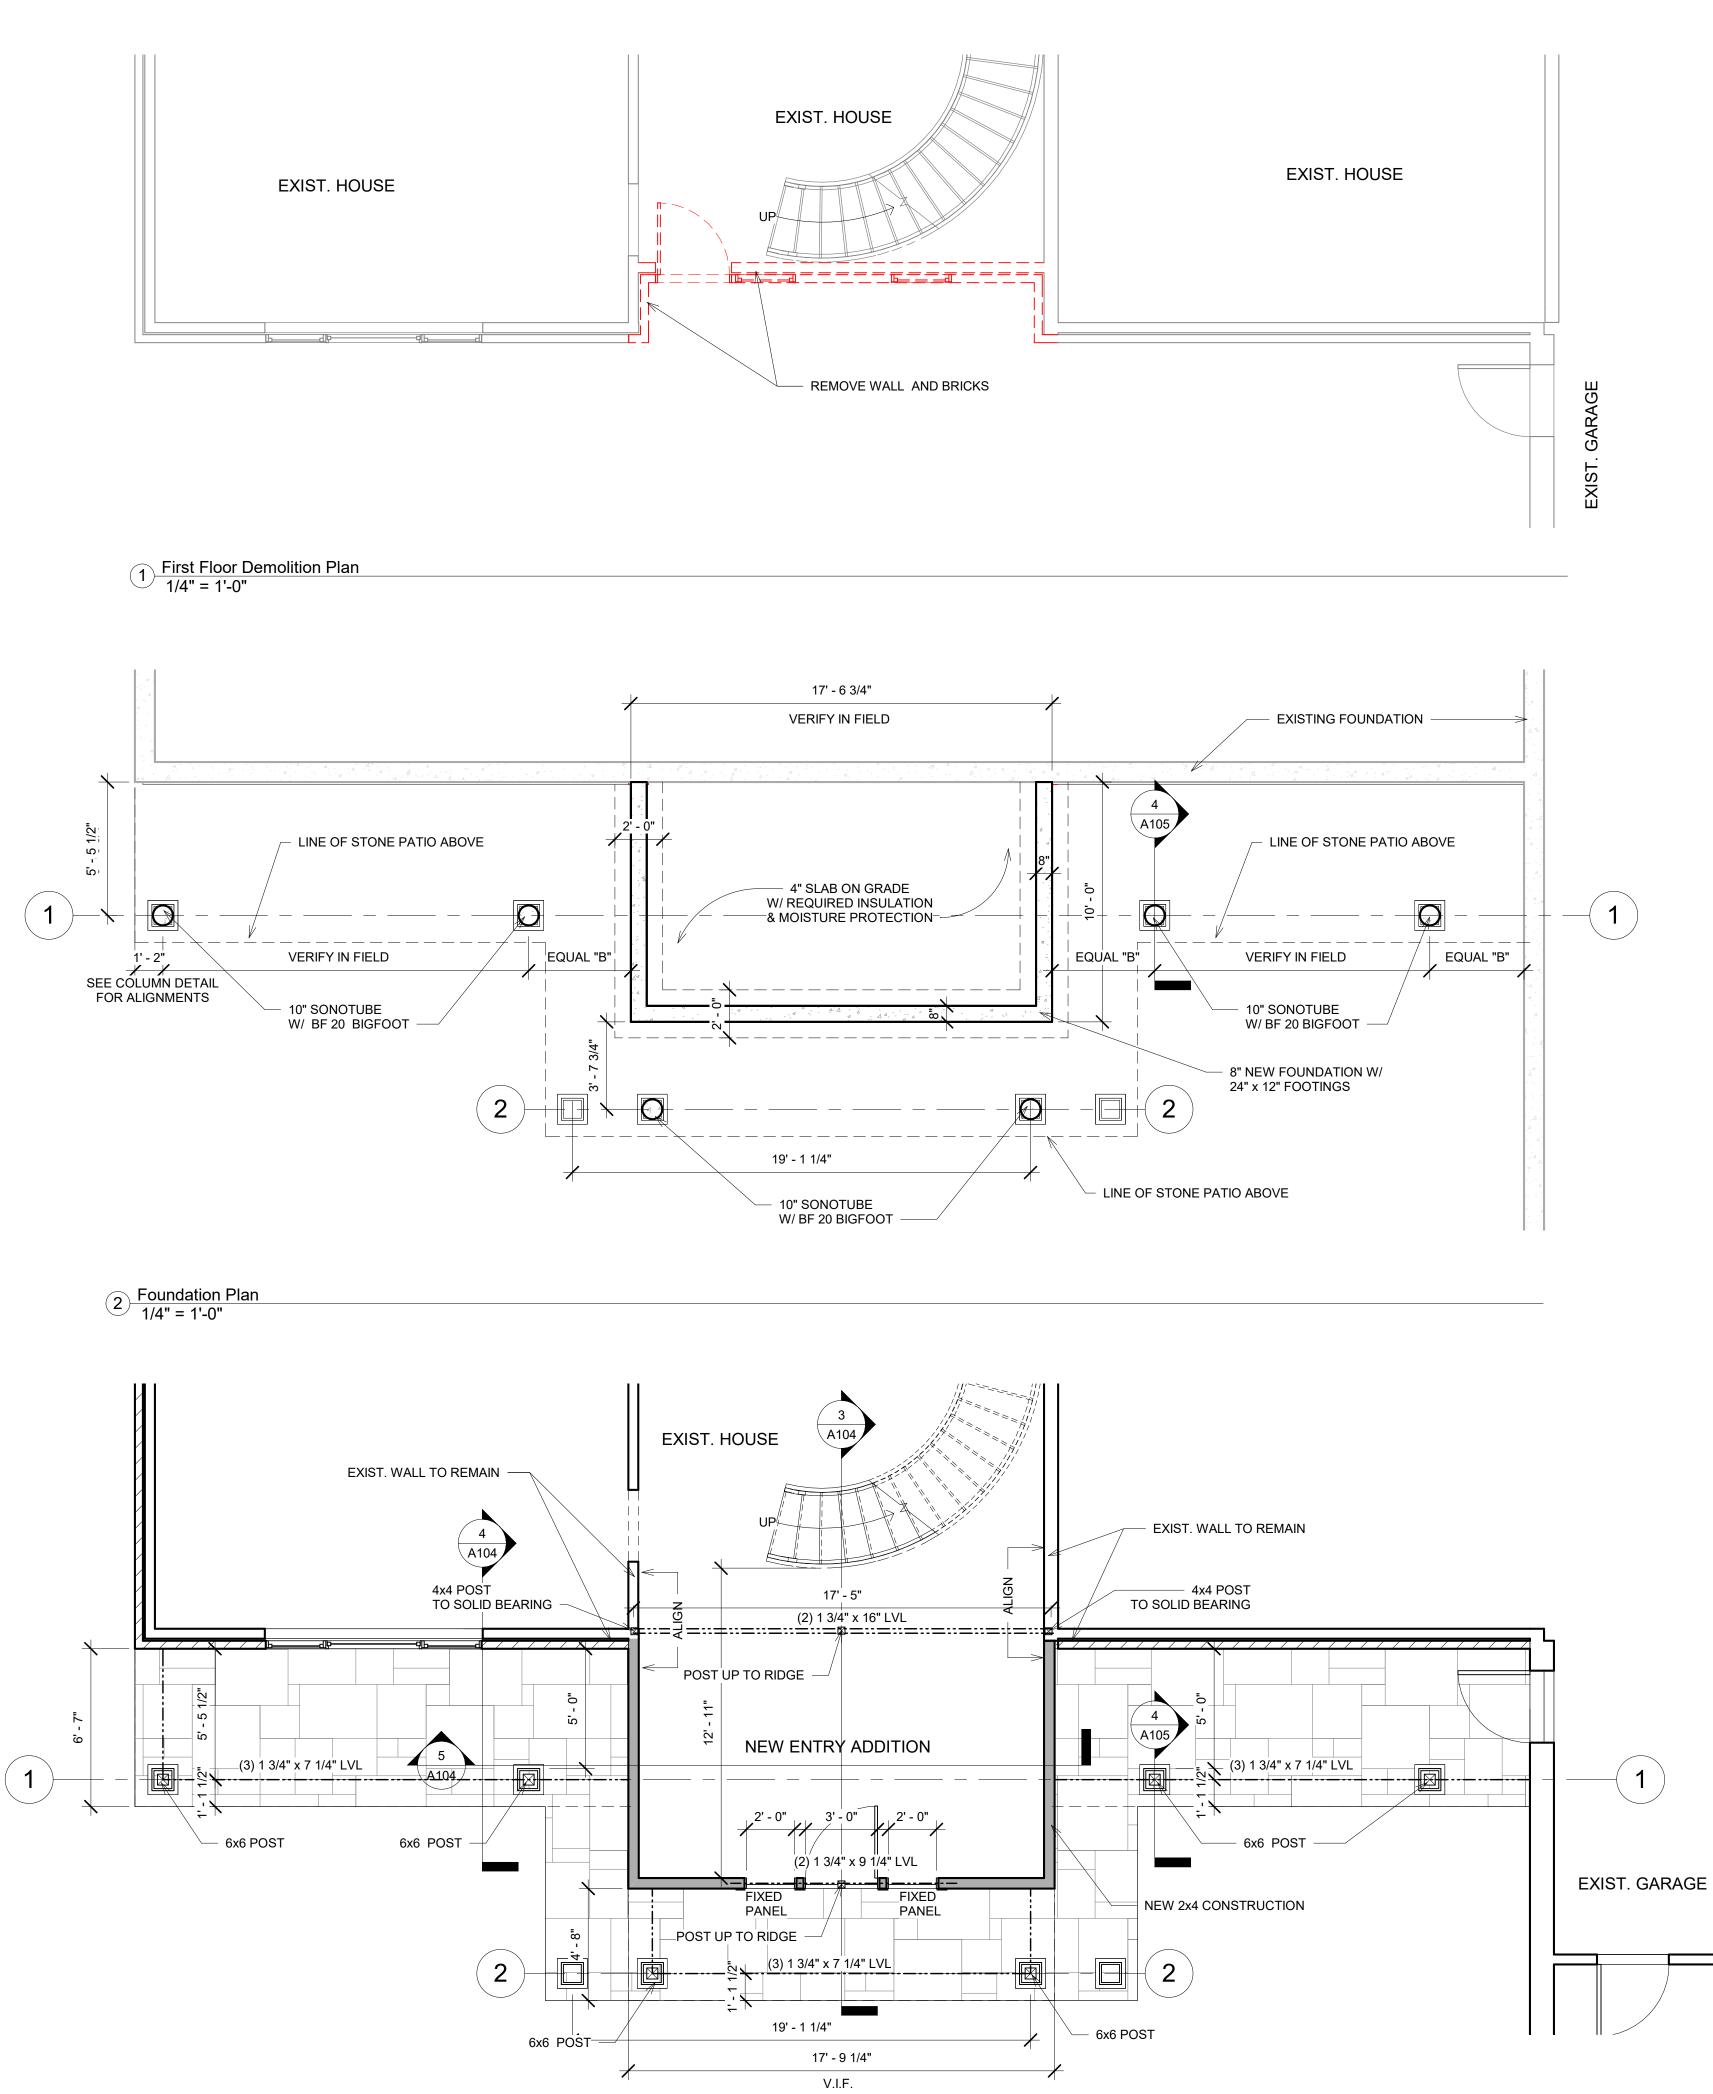
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DRAWING NUMBER - DETAIL SHEET NUMBER - DRAWING NUMBER - DETAIL - SHEET NUMBER - DOOR SCHEDULE NUMBER

— WINDOW SCHEDULE NUMBER



3 First Floor Proposed Plan 1/4" = 1'-0"

FRONT FOYER ADDITION TO

2 Northway, BRONXVILLE, NY

DARIUSZ P. KULINSKI

ARCHITECT

1 BATES COURT, UNIT 401 NORWALK, CT 06854 T: 203 952 3037 E: DARKCONN95@LIVE.COM

CONNECTICUT - NEW YORK - CALIFORNIA STRUCTURAL ENGINEER

CARL E. RUSPINI, M.S.,P.E. 414 PEPPER STREET MONROE, CT 06468 T: 203 410 9482



REV	DATE	ISSUE	
KEY PLAN			

PERMIT ISSUE

eSign:7/16/2021 1:02:58 PROJECT ISSUE Issue Date SHEET ISSUE 03/110/21 SCALE 1/4" = 1'-0" FORMAT ARCH D


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SHEET NO




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A102



1

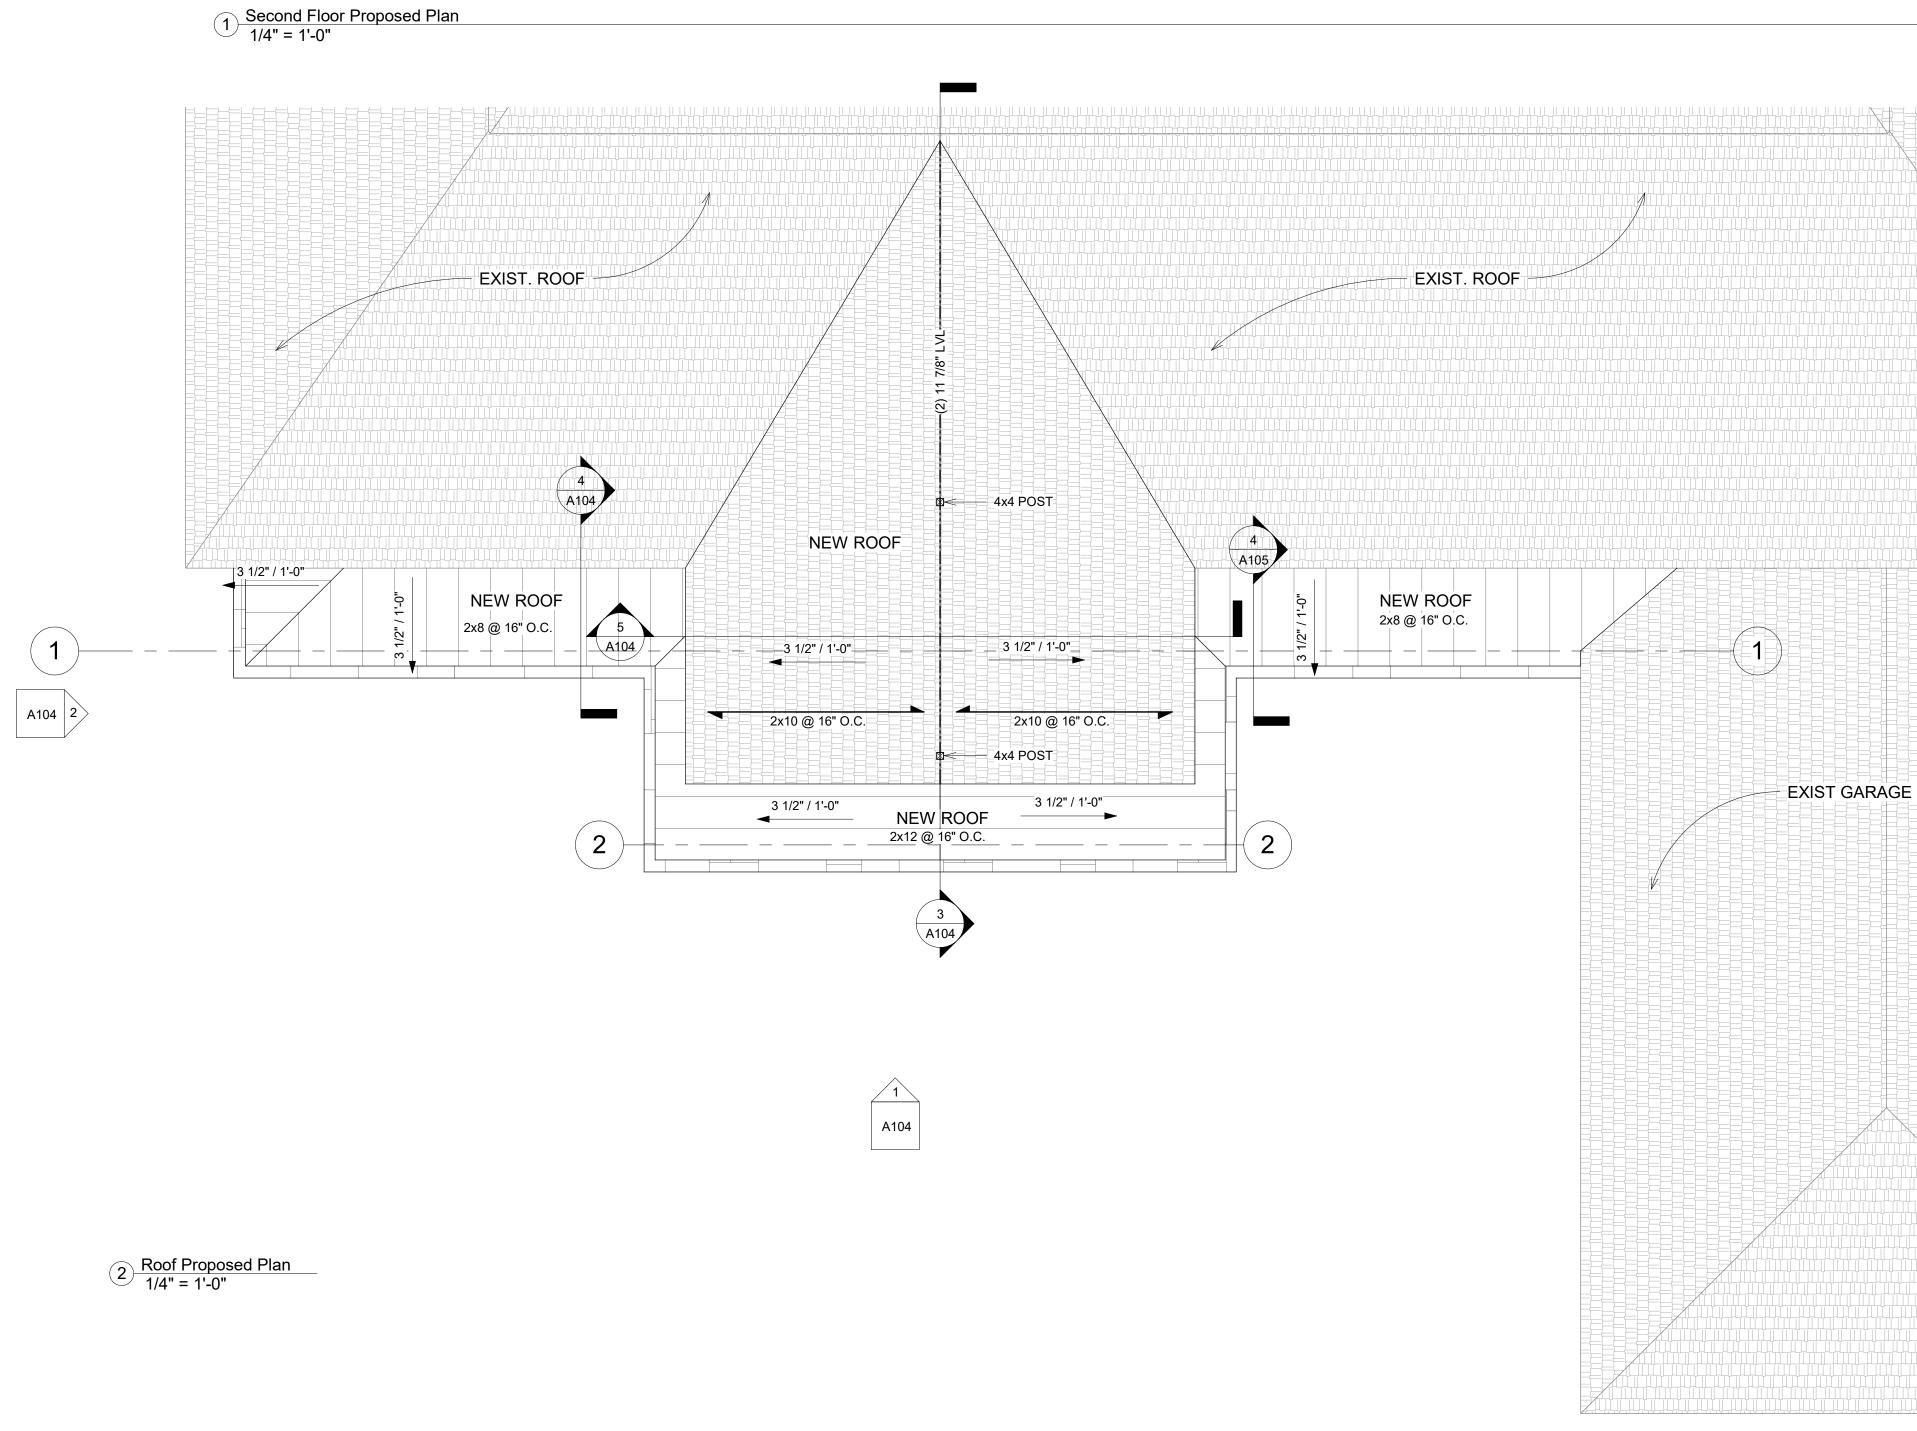

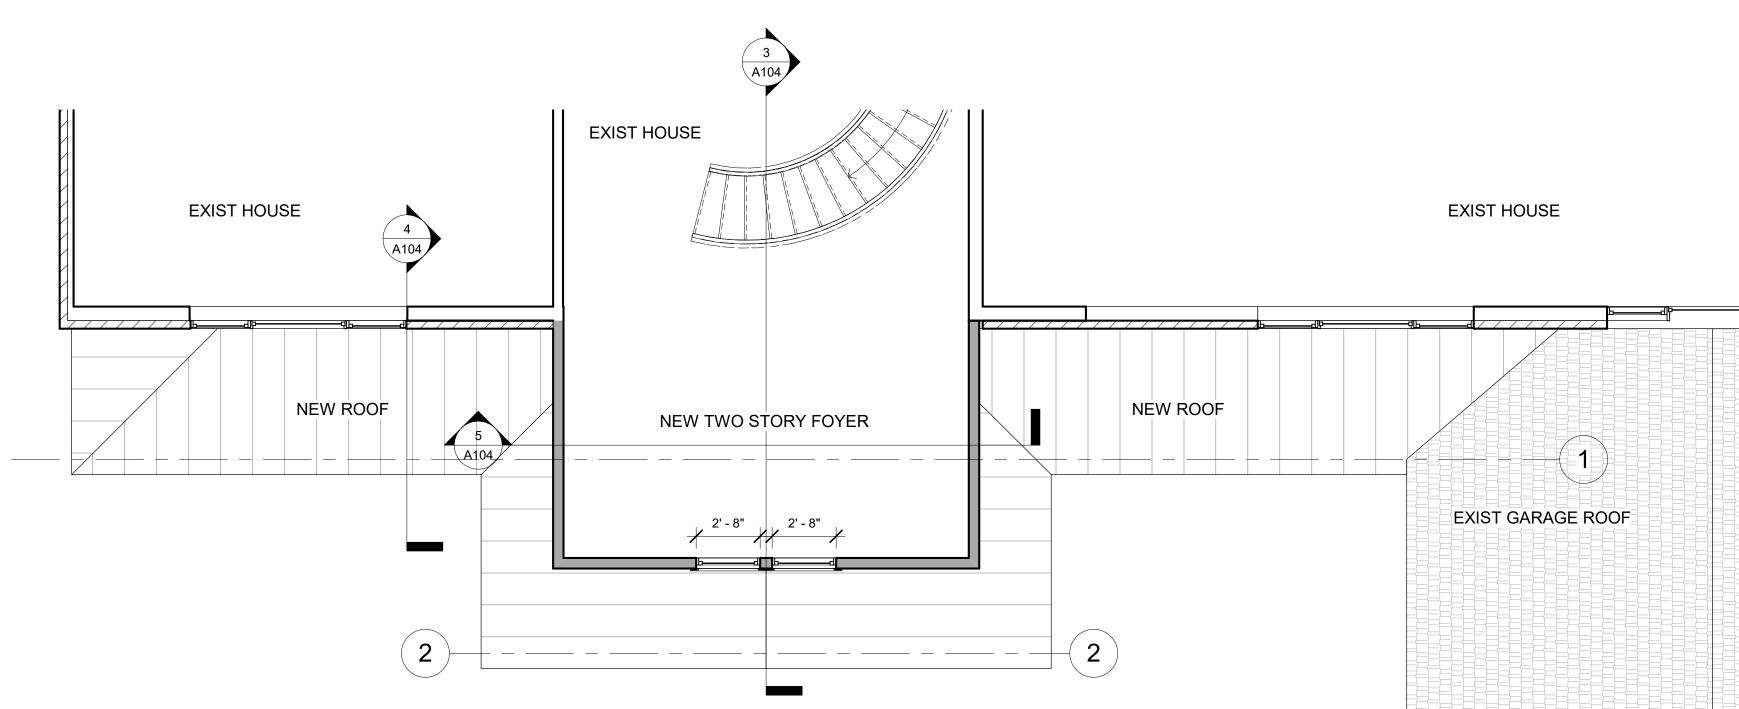FRONT FOYER **ADDITION TO**

2 Northway, BRONXVILLE, NY

DARIUSZ P. KULINSKI

ARCHITECT

1 BATES COURT, UNIT 401 NORWALK, CT 06854 T: 203 952 3037 E: DARKCONN95@LIVE.COM

CONNECTICUT - NEW YORK - CALIFORNIA STRUCTURAL ENGINEER

CARL E. RUSPINI, M.S.,P.E. 414 PEPPER STREET MONROE, CT 06468 T: 203 410 9482



-			
REV	DATE	ISSUE	
REV	DATE	ISSUE	
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	DATE	ISSUE	
KEY	DATE	ISSUE	
	DATE	ISSUE	
KEY	DATE	ISSUE	

PERMIT ISSUE

eSign:7/16/2021 1:02:58 PROJECT ISSUE Issue Date SHEET ISSUE 03/110/21 SCALE 1/4" = 1'-0" FORMAT ARCH D


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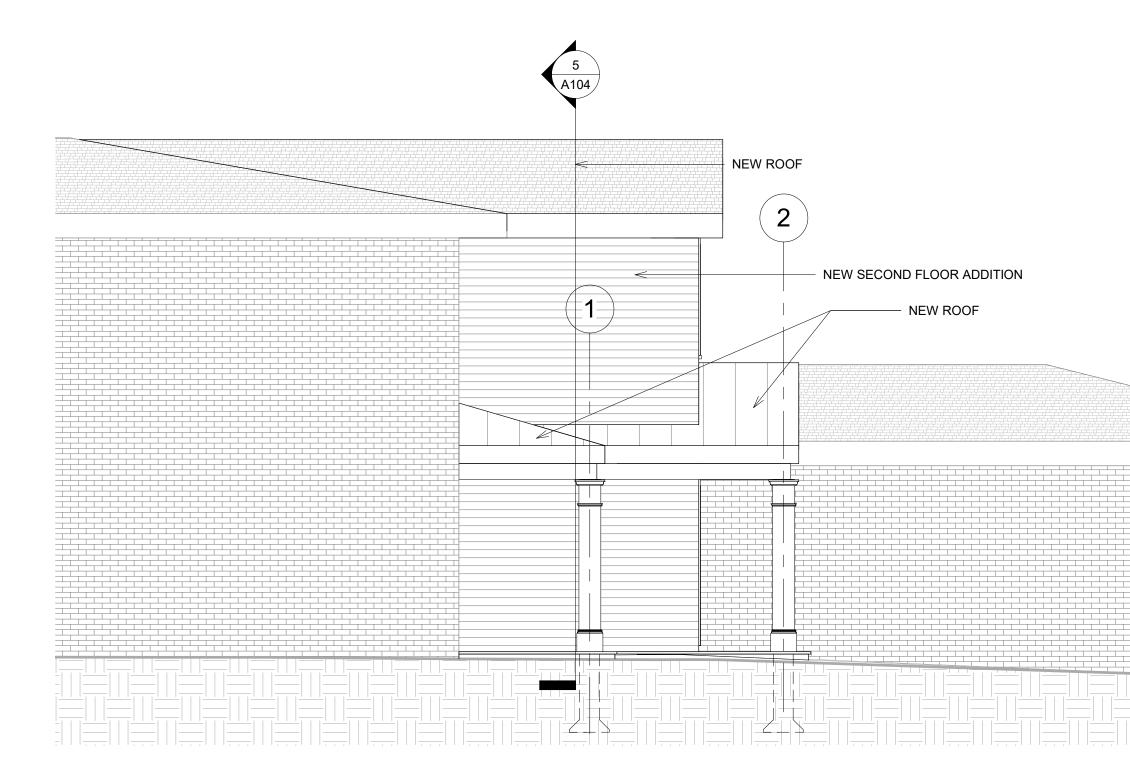
SHEET NO

FLOOR PLAN


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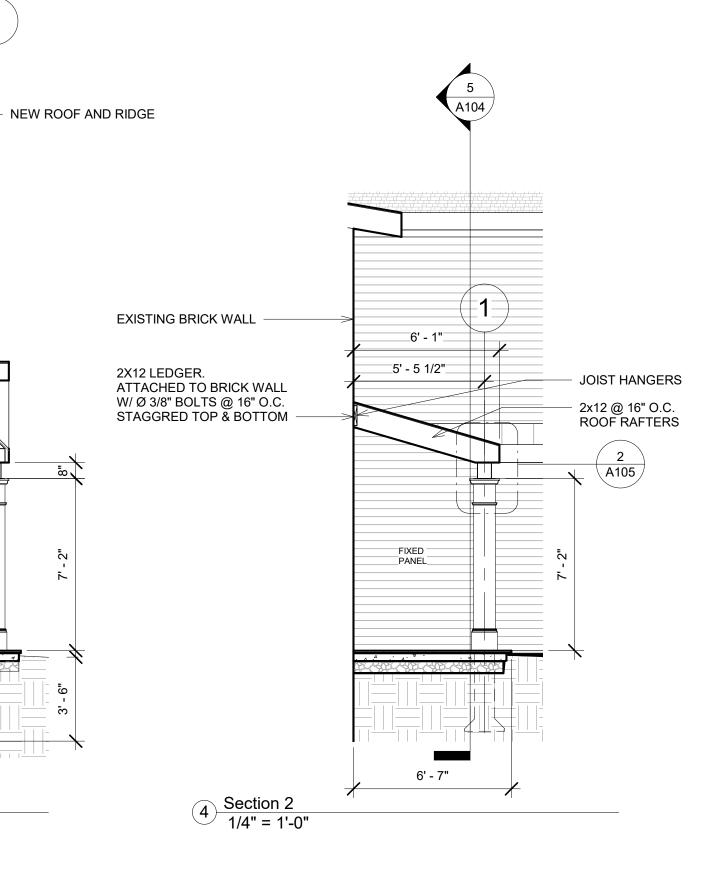


2 Side Elevation 1/4" = 1'-0"

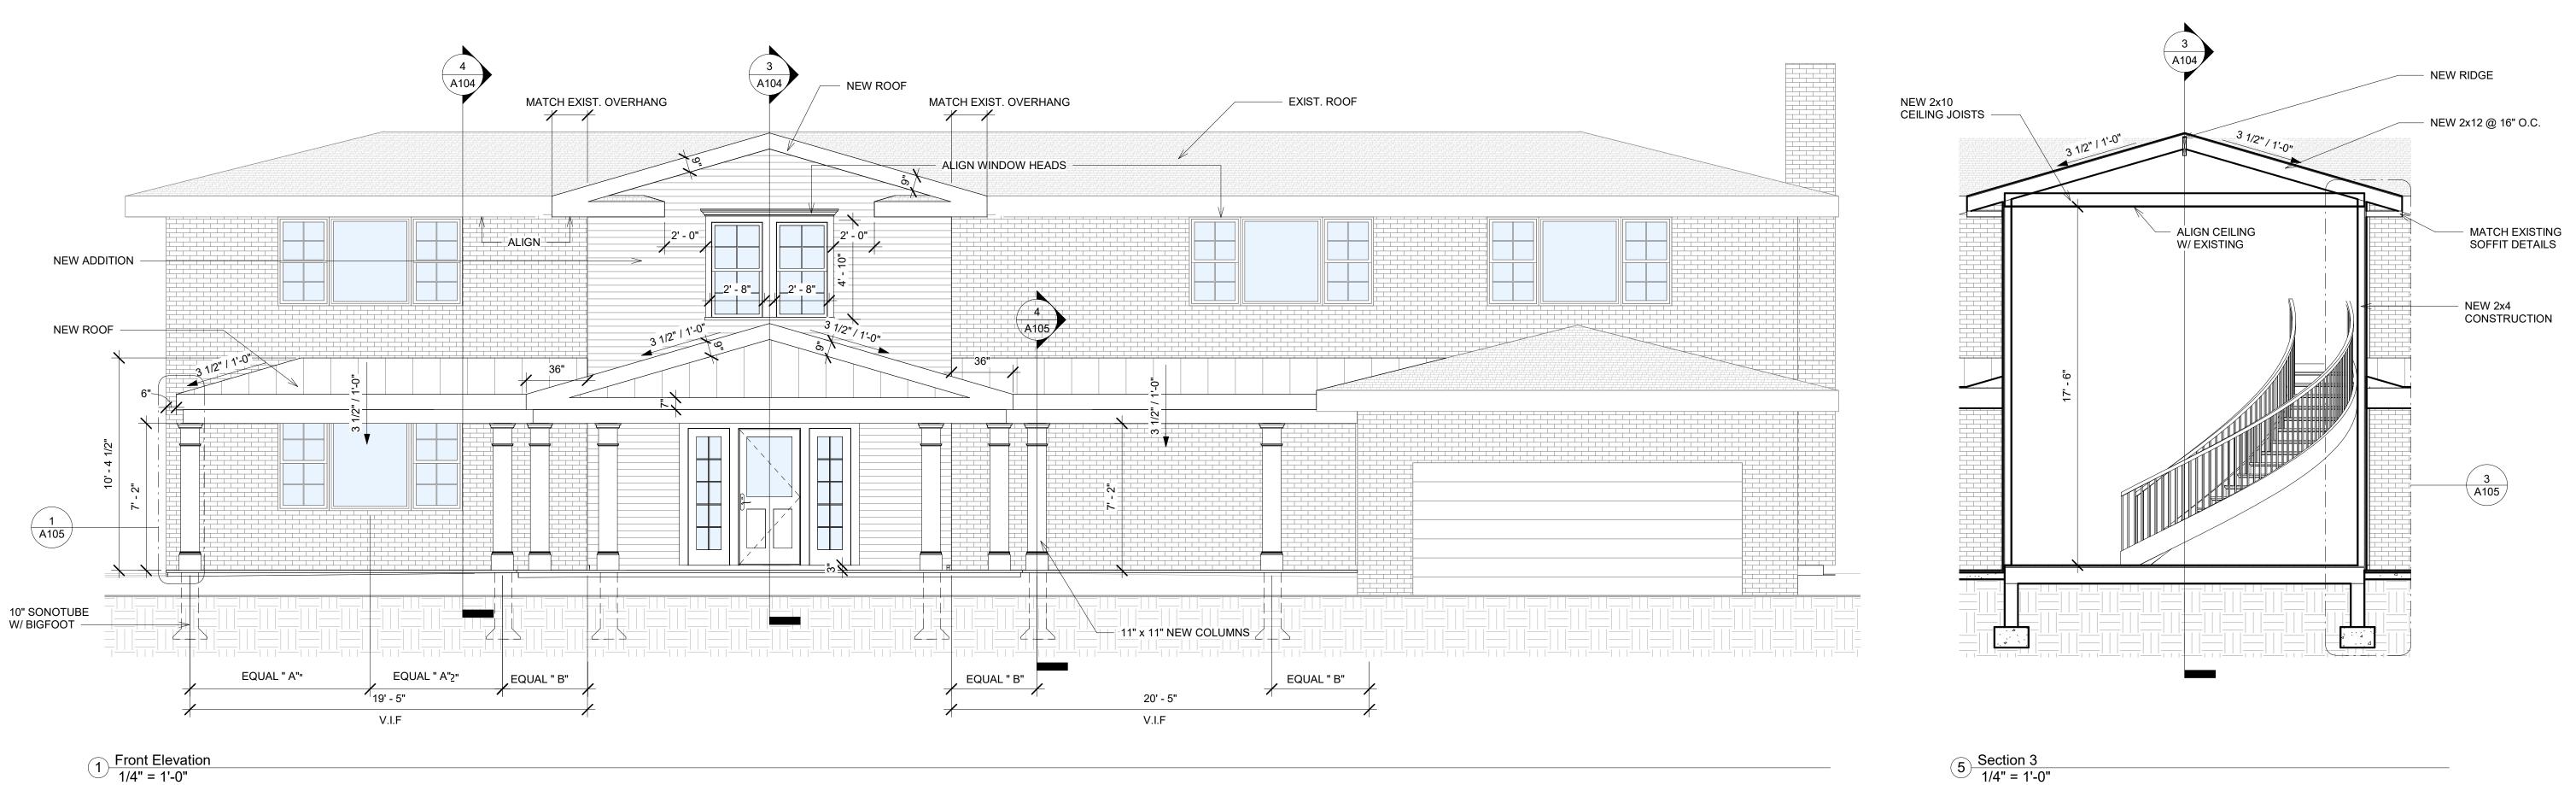

3 Section 1 1/4" = 1'-0"

5 Section 3 1/4" = 1'-0"

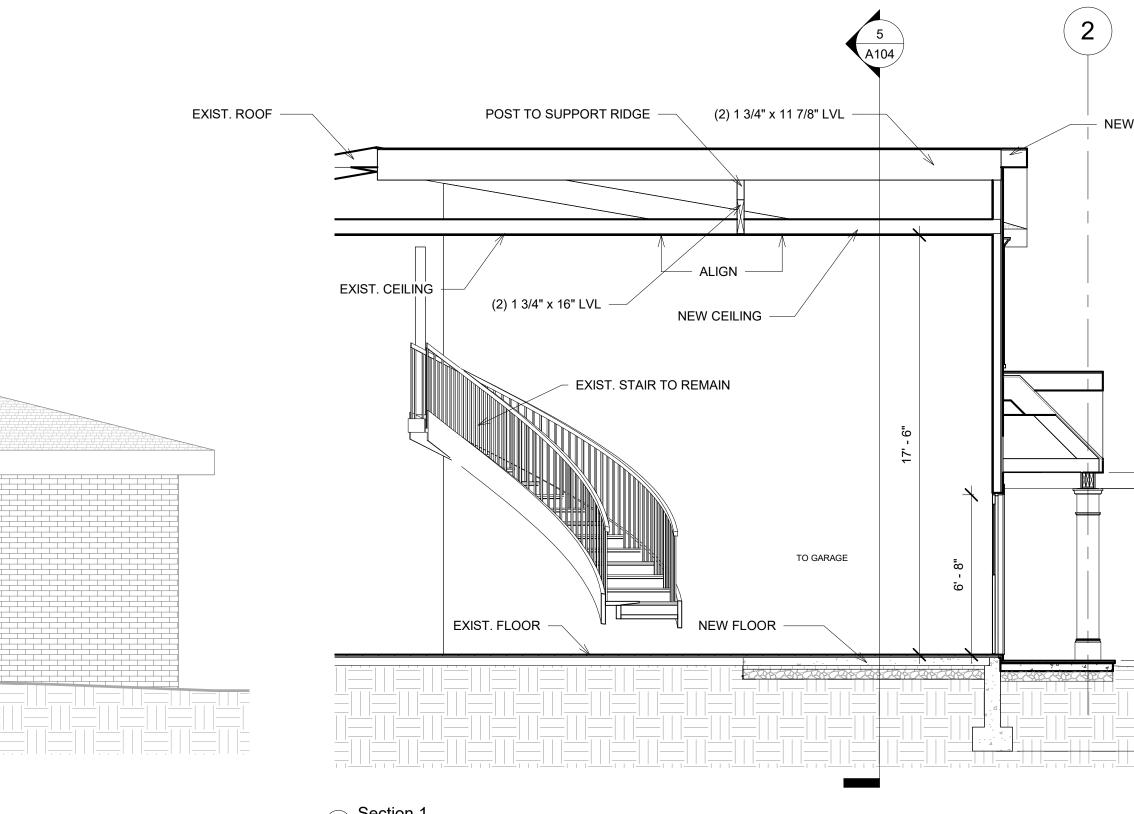

FRONT FOYER ADDITION TO

2 Northway, BRONXVILLE, NY

DARIUSZ P. KULINSKI

ARCHITECT

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CONNECTICUT - NEW YORK - CALIFORNIA STRUCTURAL ENGINEER

CARL E. RUSPINI, M.S.,P.E. 414 PEPPER STREET MONROE, CT 06468 T: 203 410 9482



PERMIT ISSUE

REV DATE ISSUE

KEY PLAN

eSign:7/16/2021 1:02:59 PROJECT ISSUE **Is/sue Date** SCALE 1/4" = 1'-0" SHEET ISSUE 03/10/21 FORMAT ARCH D


ELEVATIONS


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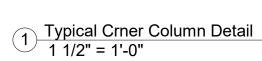
SHEET NAME


SHEET






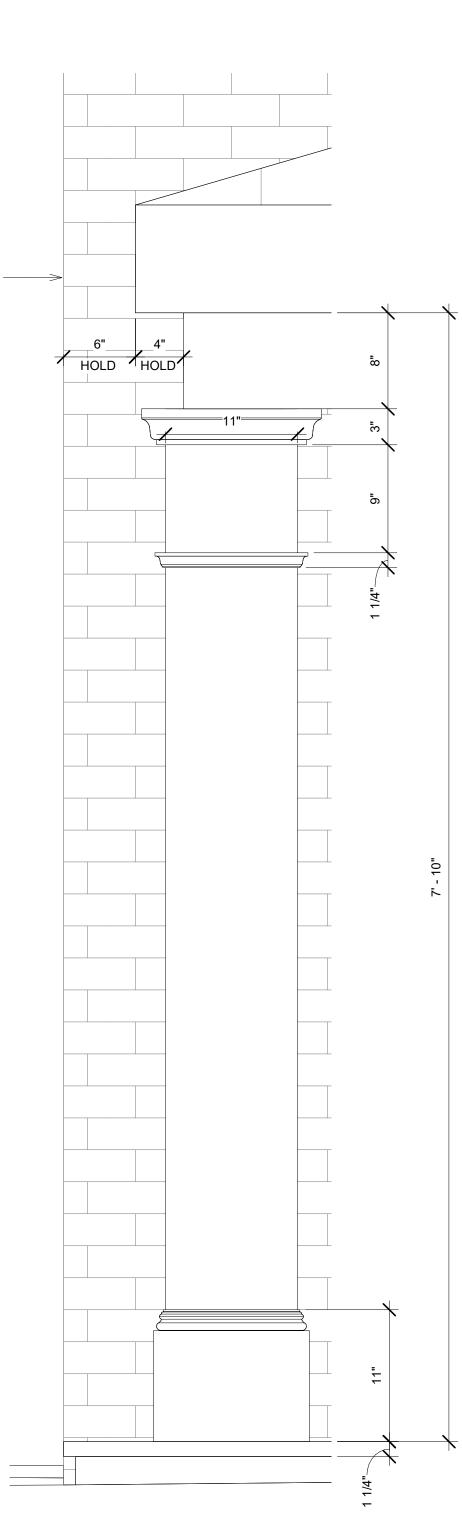

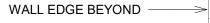

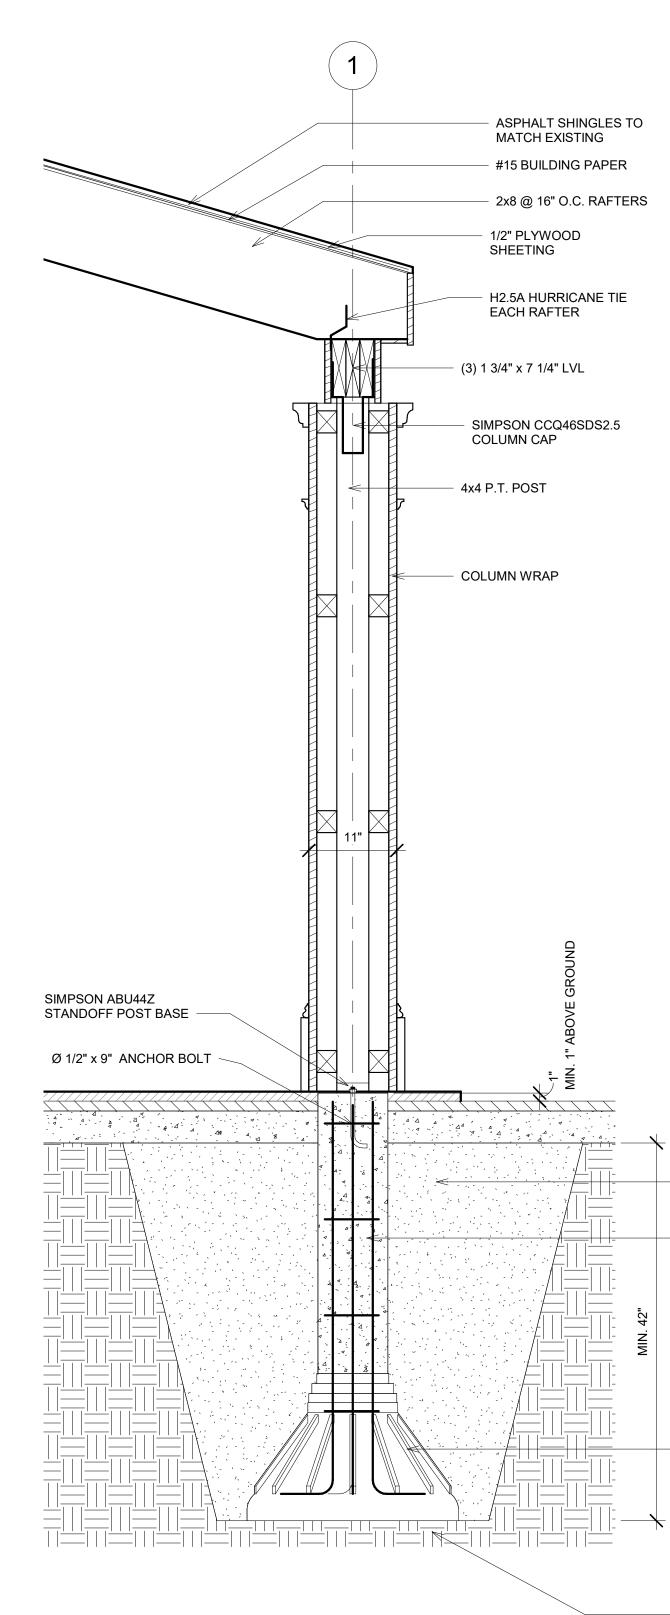


4 Section 4 1" = 1'-0"

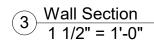

UNDISTURBED SOIL

BF20

#3 TIES 12" O.C.

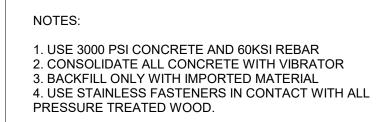

MATERIAL.

10" CONCRETE PIER WITH (4) #4 BARS 9" BOTTOM HOOK &

- SELECT GRANULAR BACKFILL. DO NOT BACKFILL WITH EXISTING ON SITE

- COLUMN WRAP

4x4 P.T. POST

4

X

COLUMN CAP

SIMPSON CCQ46SDS2.5


- (3) 1 3/4" x 7 1/4" LVL

- H2.5A HURRICANE TIE EACH RAFTER

1/2" PLYWOOD SHEETING

- 2x8 @ 16" O.C. RAFTERS

- ASPHALT SHINGLES TO MATCH EXISTING - #15 BUILDING PAPER

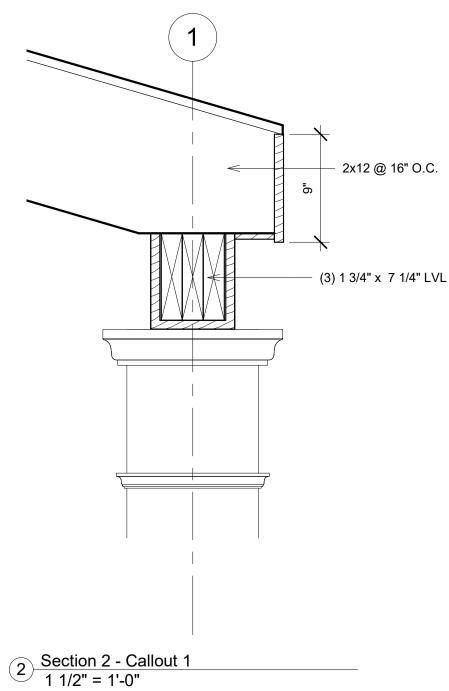

1/2" GYPSUM BOARD

FINISH FLOOR

W/WWM -

GRAVEL


INSULATION

MATCH EXISTING

4" CONCRETE SLAB

Foundation Wall

≻ 0-210-210-210-210-210 A 'A'-

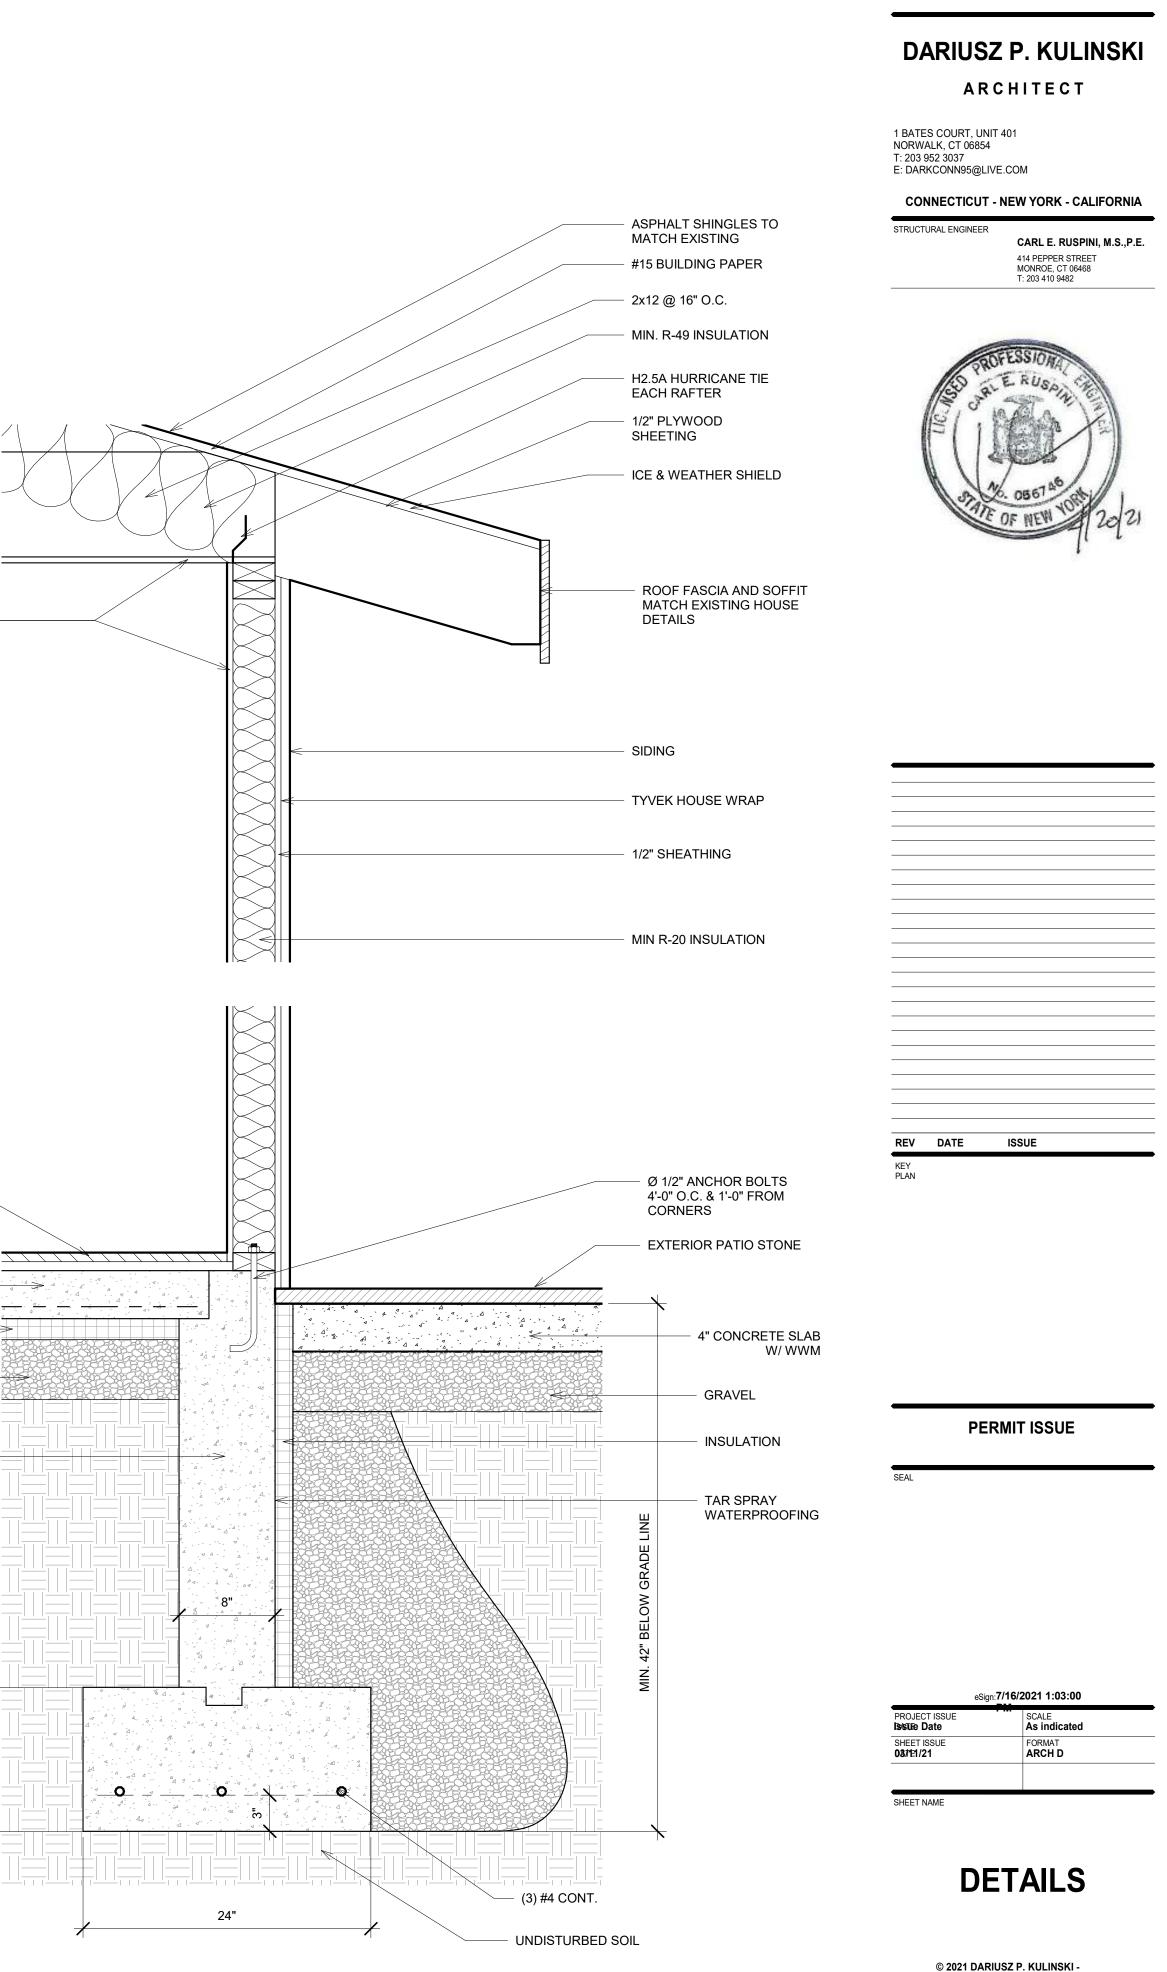






SHEET

FRONT FOYER ADDITION TO

2 Northway, BRONXVILLE, NY

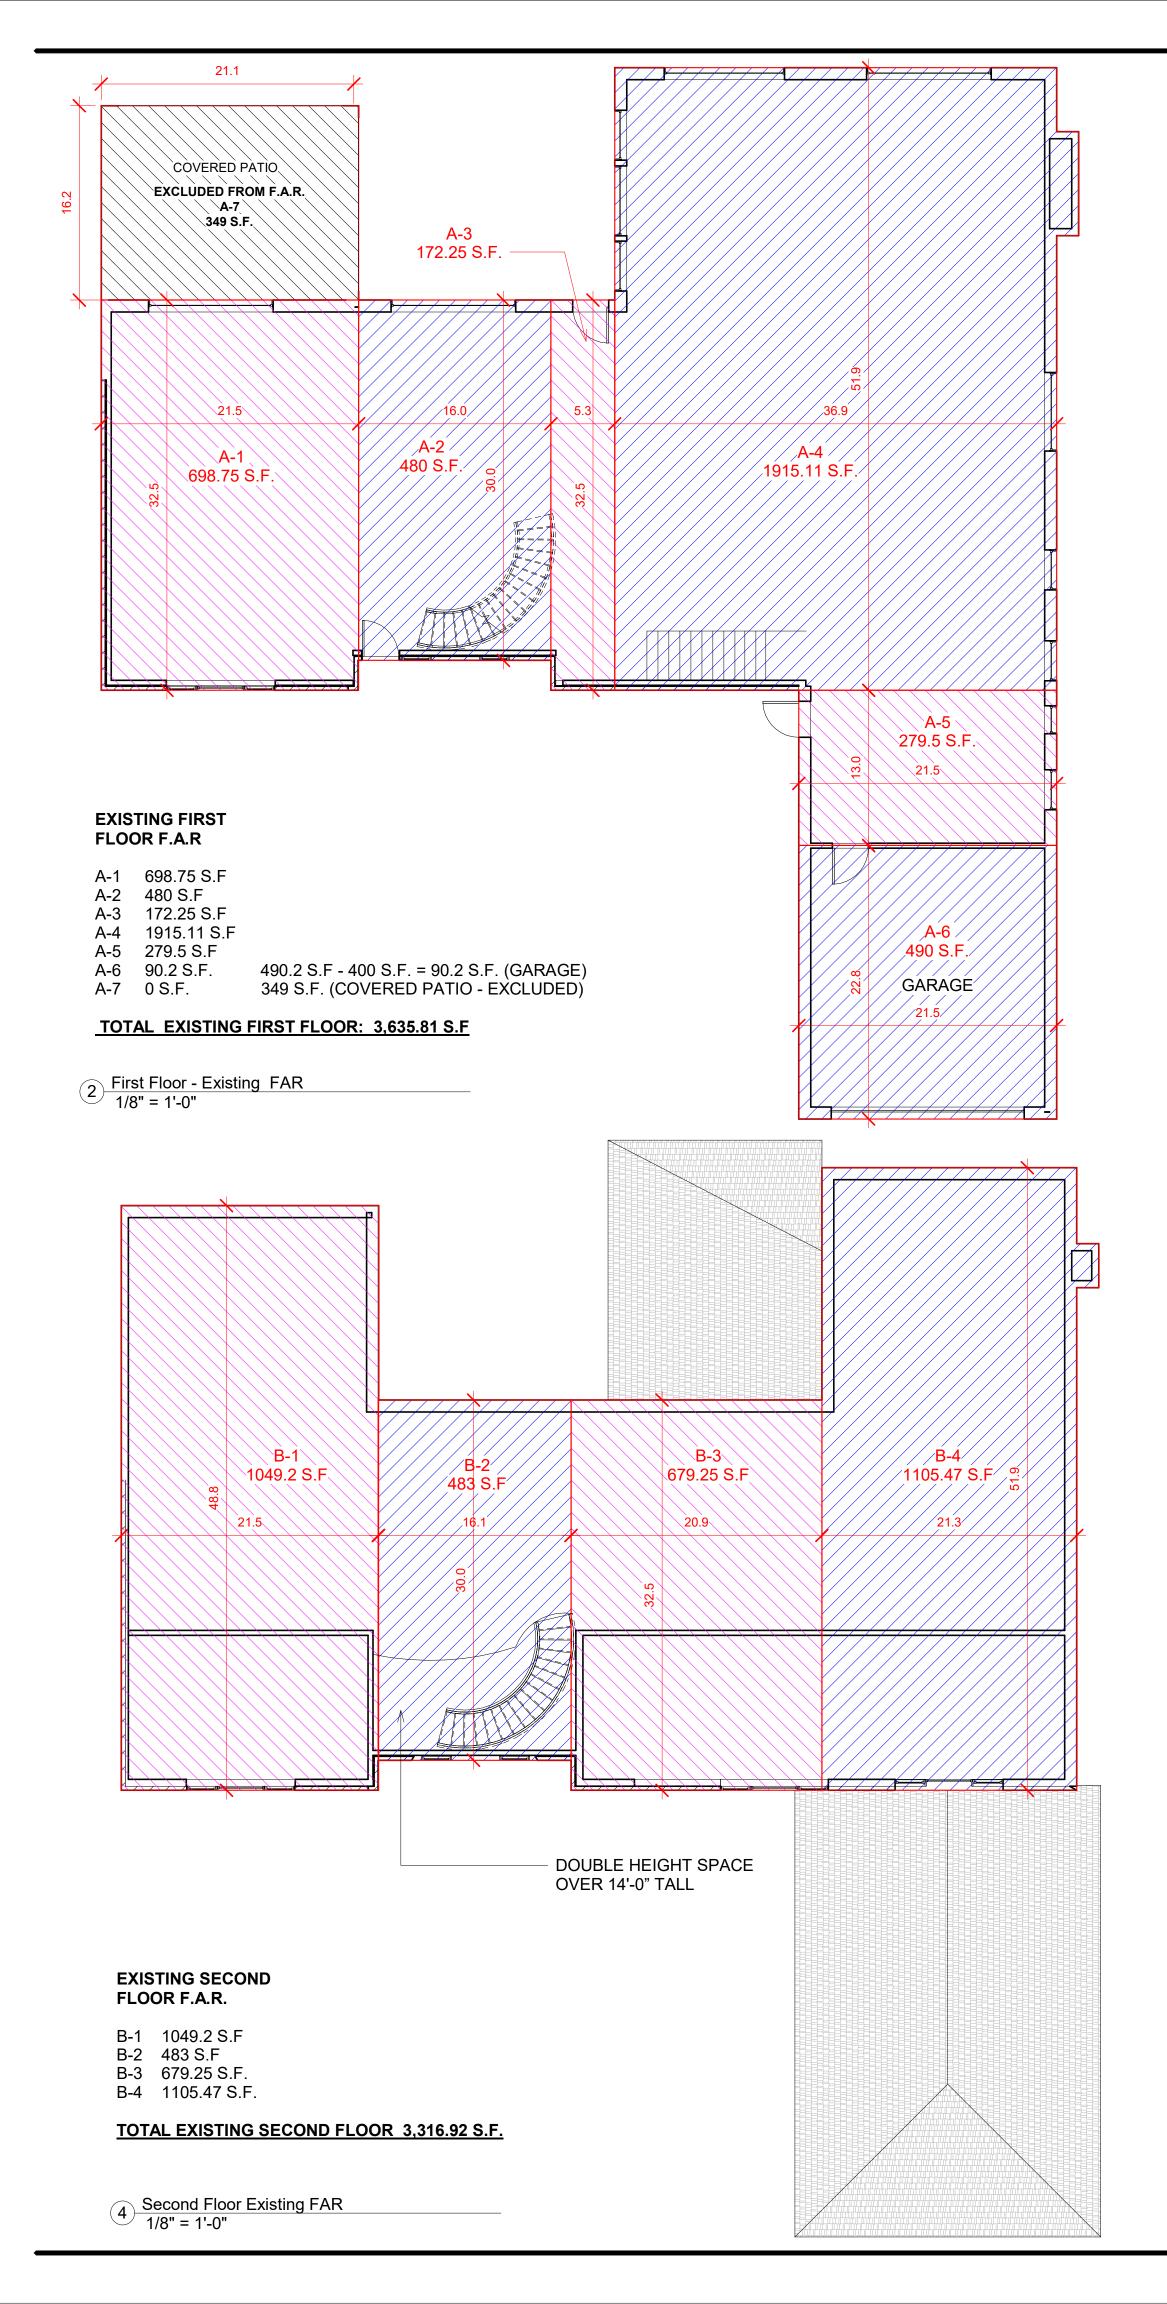


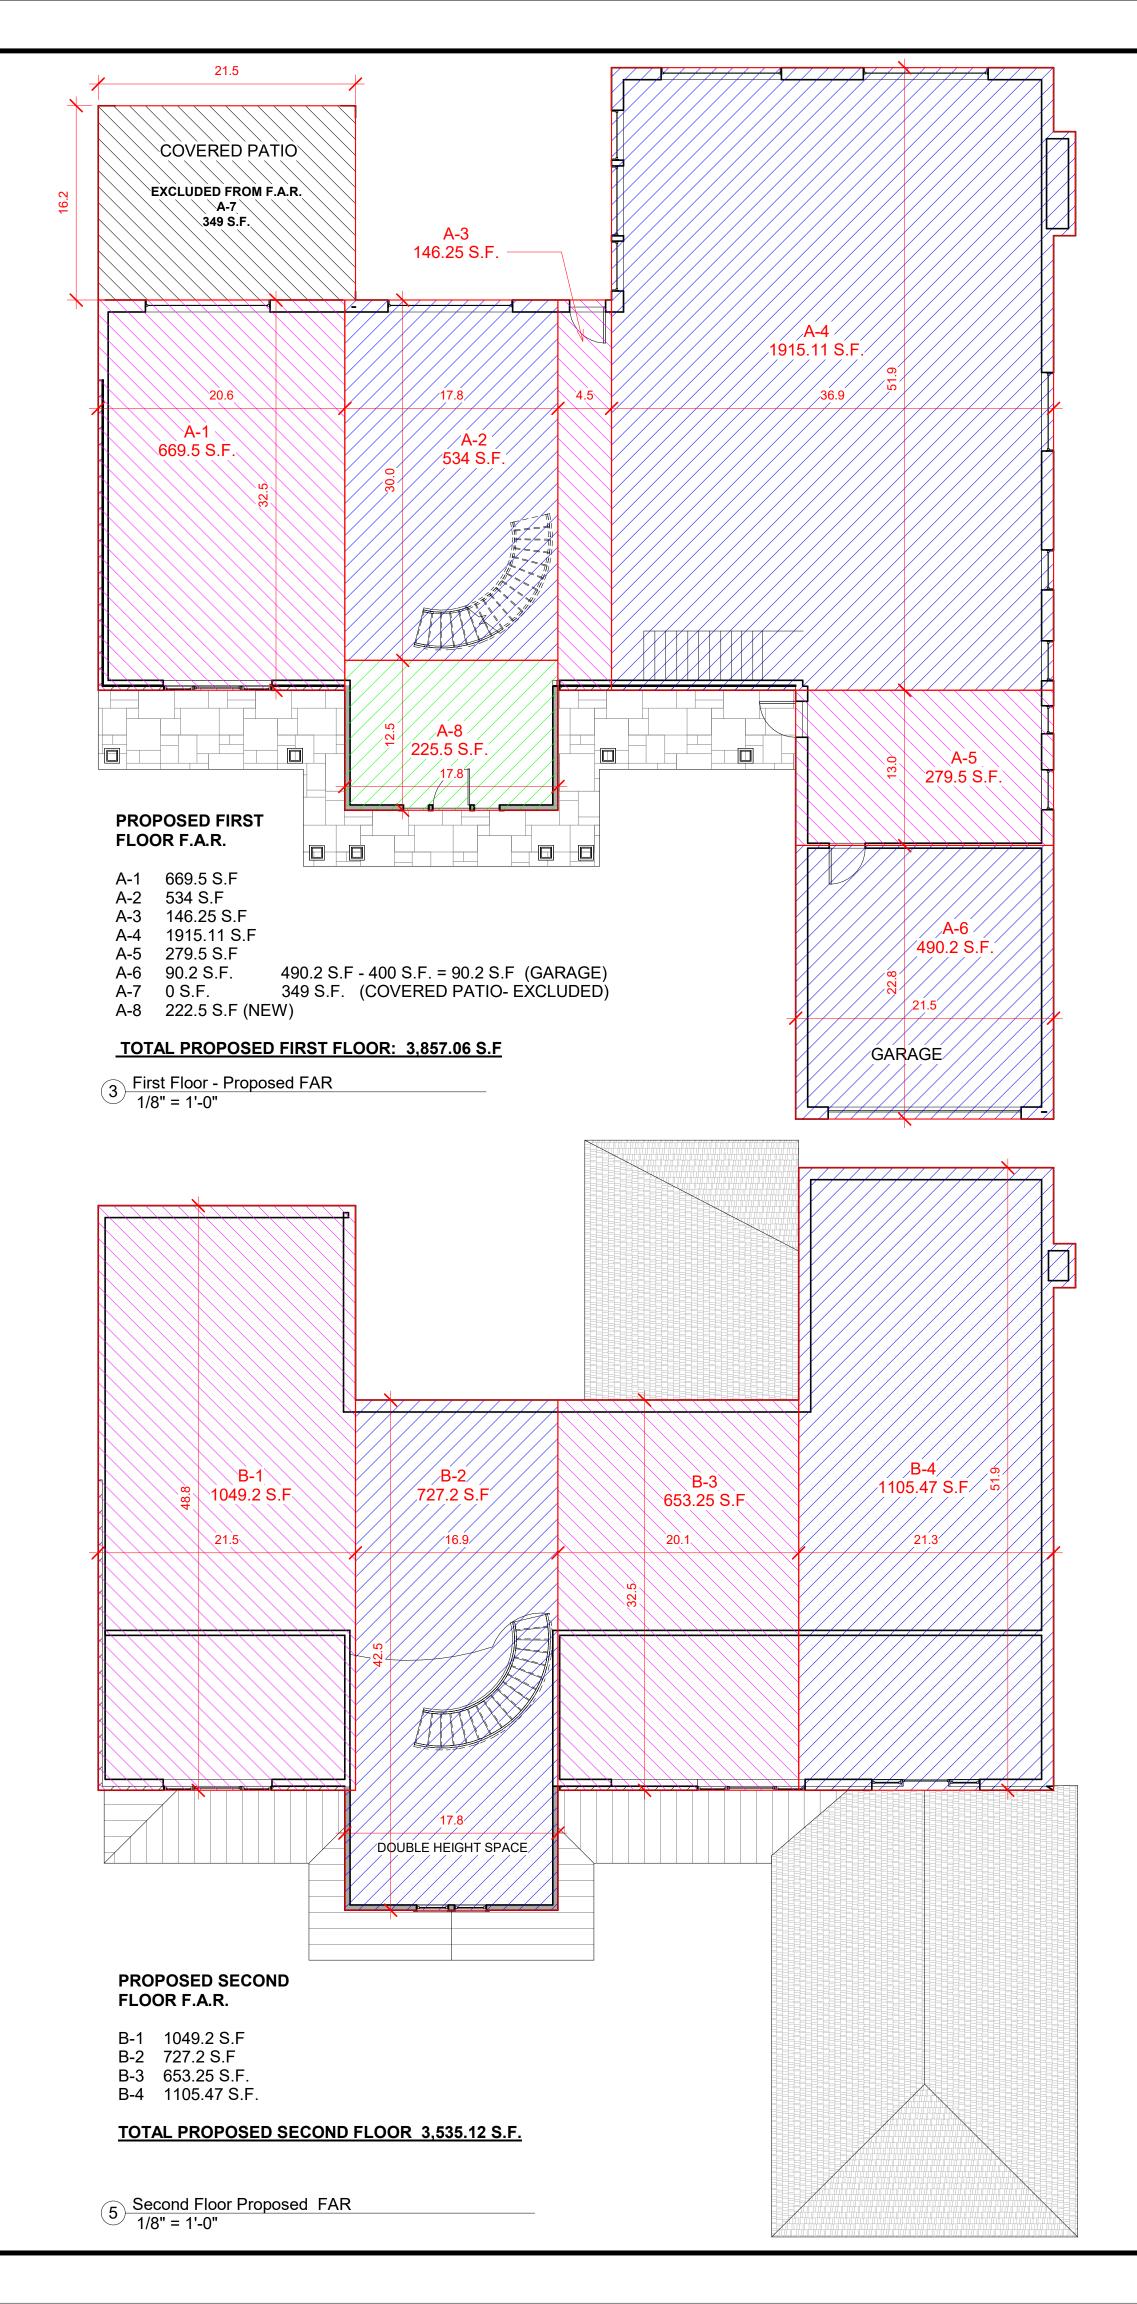

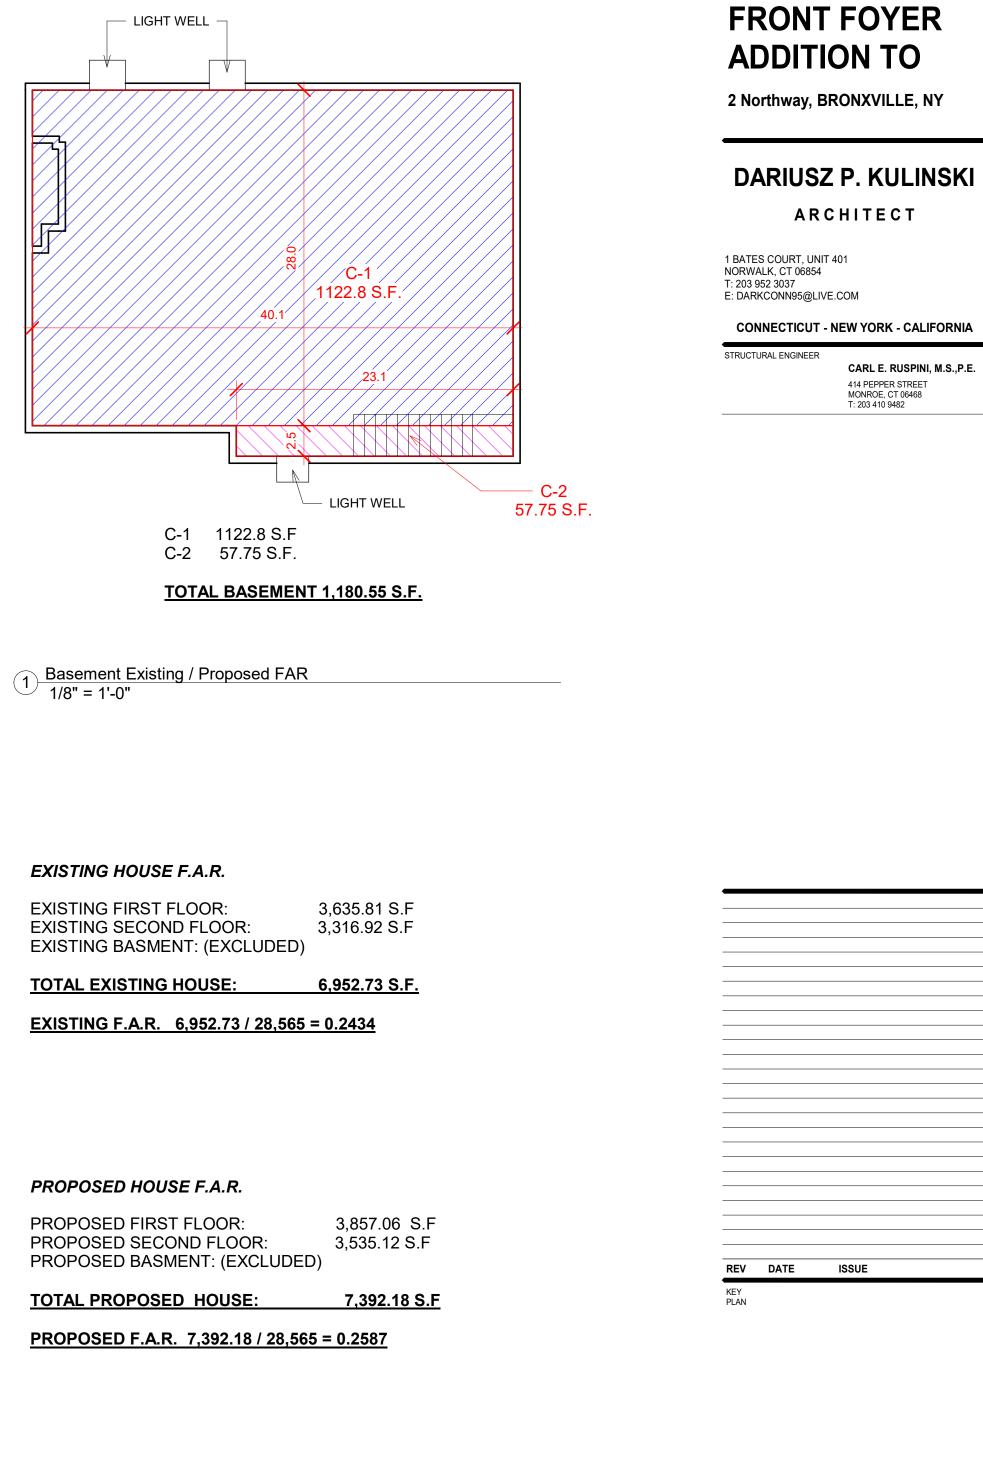

- LIGHT WELL

LOT AREA:	28,565.96 S.F. / (0.66 AC)
MAX. ALLOWABLE F.A.R	0.2275 / (6,540 S.F.)
PROPOSED F.A.R.	0.2587 / (7,392 S.F.)
EXISTING F.A.R.	0.2434 / (6,952 S.F.)
F.A.R. INCREASE (FROM EXISTING)	440 S.F. / 0.125 / (5%)
VARIANCE REQUIRED (PROPOSED - ALLOWED)	0.0312 / (852 S.F)

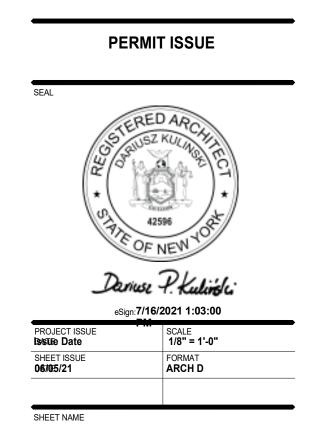

FAR CALCULATIONS

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A107

	EXISTING PROPOSED		SUB TOTAL
BASEMENT ^(b)	1,180.55	1,180.55	0.0
1 ST FLOOR	3,635.81	3,857.06	3,857.06
2 ND FLOOR	3,316.92	3,535.12	3,535.12
3 RD FLOOR ^(d)	n/a	n/a	n/a
ATTIC ^(d)	n/a	n/a	n/a
GARAGE (¢)	490.2	490.2	90.2
	ACTUAL TOTAL	BUILDING FLOOR AREA =	7,392.18
	ACTUAL LOT AREA =	28,565.96	
	able, interpolate if necessary) =	0.2275	
	MAXIMUM PERM	AITTED BUILDING FLOOR AREA	
(ACTUAL LOT AREA X PERMITTED F.A.R). =			6,498.75


***Please refer to the Village of Bronxville Municipal Code Section 310- 22 Supplementary Regulations.

Zoning Compliance Worksheet – District 'AA'

" = 1'-0" ite Plan

N N

																	_
Bronxville District 'AA'	District	Height	Stories	Lot Area	Lot Width	Lot Depth	Front Yard	Side Yard with Garage	Side Yard without Garage	Side Yard corner lot with garage	Side Yard Corner Lot without garage	Side Yard w/ alternative with a garage	Rear Yard	Fence > than 6-1/2' H	ACC Building	Max Building coverage	p
Bronsville District 'AA' Description of Bulk Requirements	AA	30' mean Height	2-1/2	15000 sf	100'	120'	35'; alternative a) & b)	15% 35° min one side/ total 2 sides	27/42' one side/ total 2 sides	307/15 side opp primary front/ other side	30'/ 27' side opp primary front/ other side	deduct 5*	32"	Same as building	No closer than front of principal building, planning may issue special permit	22,5%	100
310-09 Code Section- https://ecode360.com/9450530		310-9B	310-9B	310- 9C	310- 9C	310- 9C	310-9D	310- 9D(2)	310- 9D(2)	310- 9D(2)	310- 9D(2)	310-9D(2)	310- 9D(3)	310- 9D(4)	310- 9D(5)	310-9E	3
Property Address:	2 NO	RTHWA	Y, BRON	XVILLE	, NY												1
Allowed	AA	30'	2.5 stories	15000 sf	100'	120'	35'	15/ 35	27/ 42'	30/ 15	30% 27		32'			22.5%	3
Existing	AA	22'	2.0	28,565	135'	+/- 200"	70.4			40.1			41.5			22.25 %	
Proposed	AA	22'	2.0	28,565	135'	+/- 200'	70.4			40.1			41.5			22.33 %	
Variance required = (proposed - allowed)	N/A	N/A	N/A	N/A	N/A	N/A	N/A			N/A			N/A			N/A	

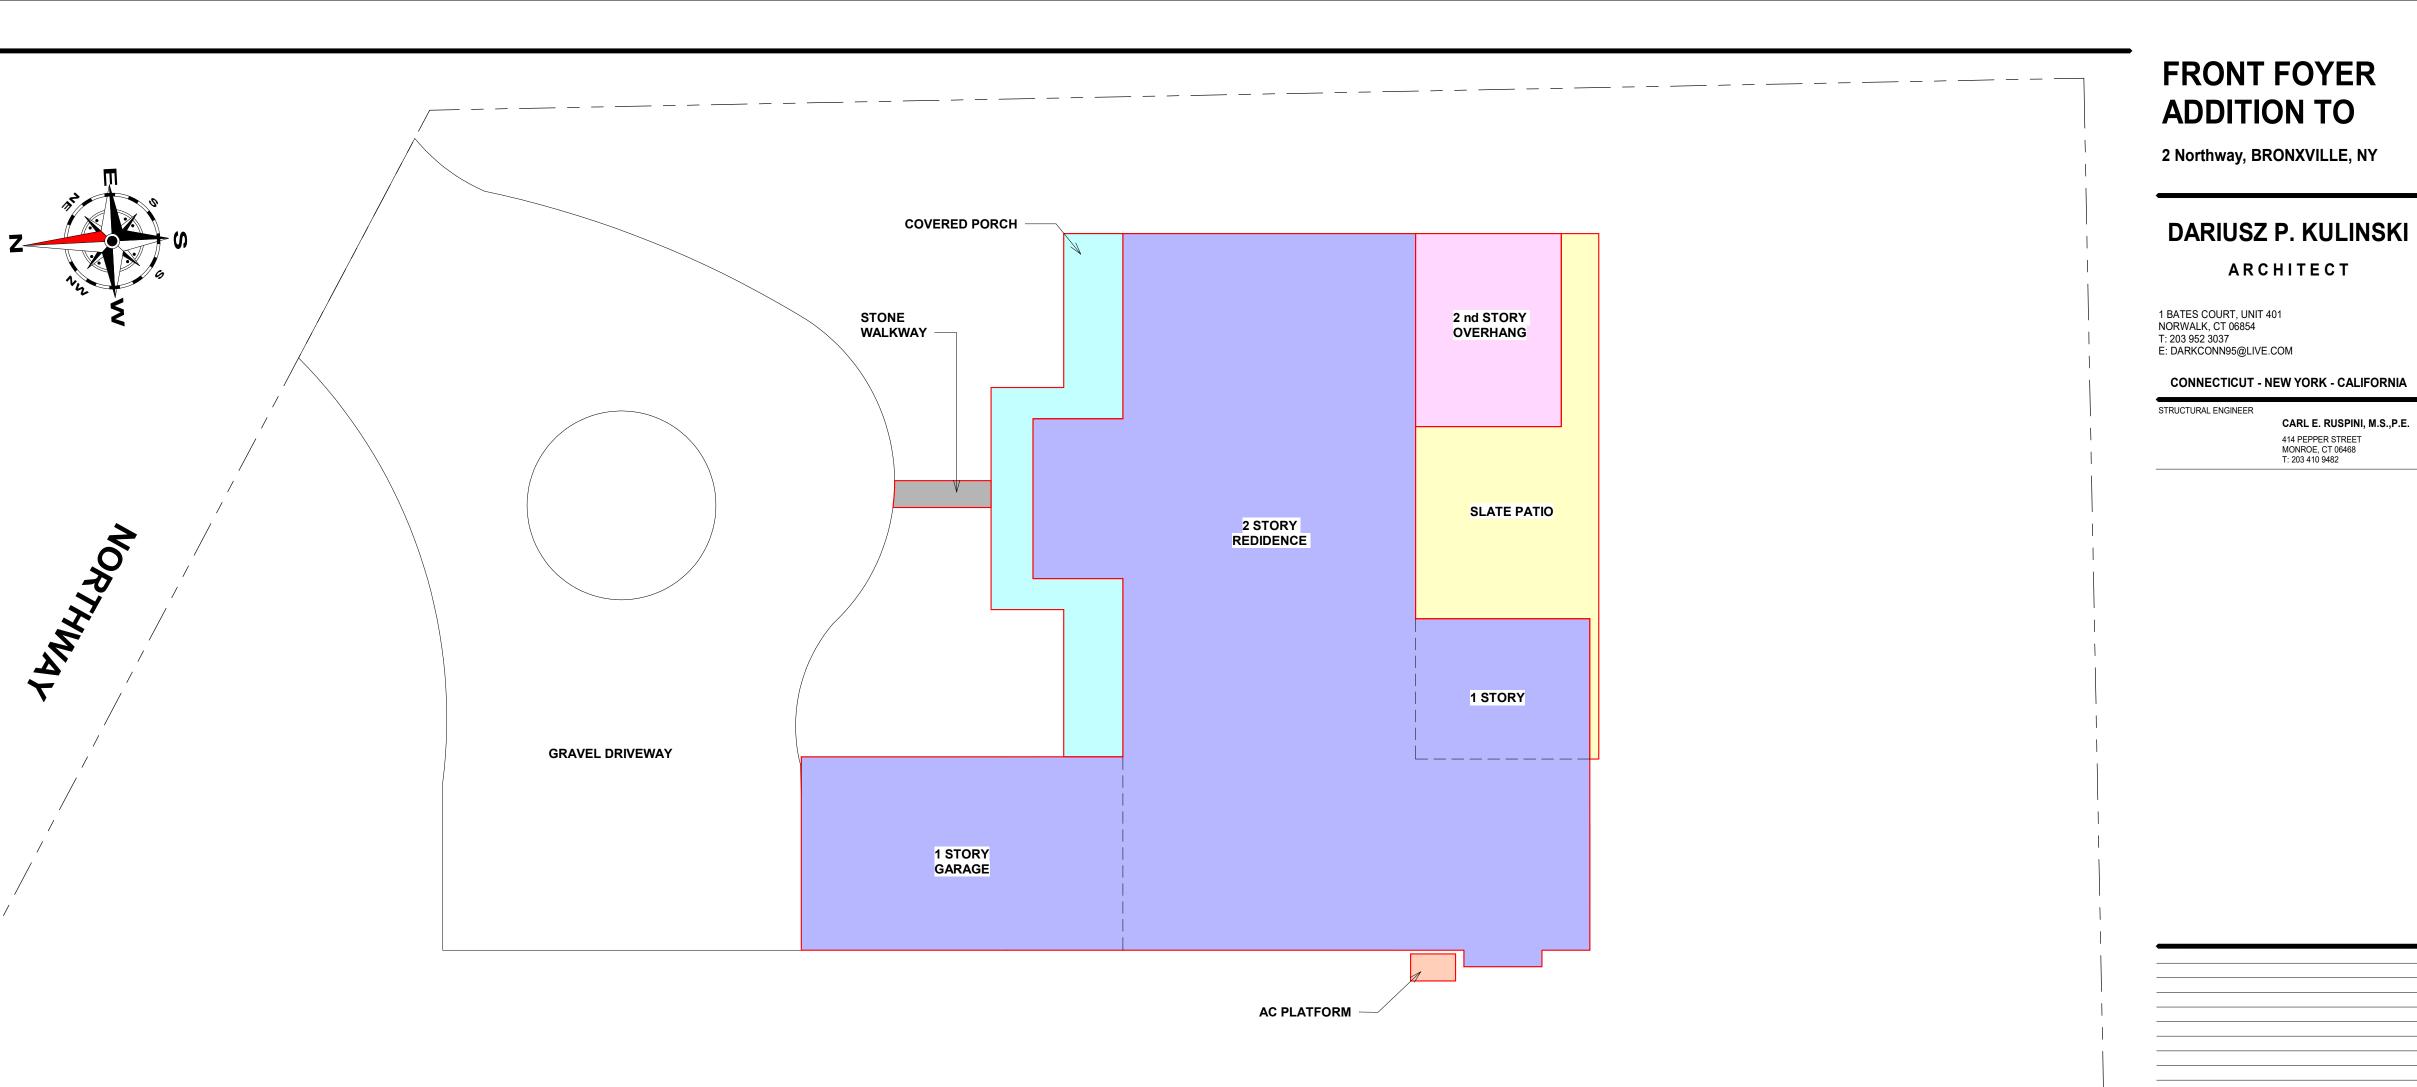

WHITE PLAINS ROAD

2 cars		55%
310-9F	310- 9G; 310- 22E	310- 9H
2 cars	0.2275	55%
	0.2434	68.36%
	0.2587	65.41%
	0.0312	HAR

EXISTING BUILDING FOOTPRINT A-1 698.75 A-2 480.0 S.F A-3 172.25 S.F. A-4 1915.11 S.F. A-5 279.5 S.F A-6 490.2 S.F A-7 349 S.F. TOTAL EXISTING BUILDING FOOTPRINT: 4,384.8 S.F.

PROPOSED BUILDING FOOTPRINT:

A-1 669.5 S.F. A-2 534.0 S.F A-3 146.25 S.F. A-4 1915.11 S.F. A-5 279.5 S.F A-6 490.2 S.F A-7 349 S.F. A-8 222.5 S.F.

TOTAL BUILDING FOOTPRINT:

4,606.56 S.F

RESIDENCE: 2nd STORY OVERHA SLATE PATIO: COVERED PORCH: WALKWAY: AC PLATFORM:

TOTAL:

BUILDING COVERAGE REQ.

BUILDING COVERAGE CALCULATIONS:

	4,823.3 S.F	
ANG:	563.3 S.F	
	540.S.F.	
	405 S.F.	
	33 S.F.	
	15 S.F.	

6,379.6 S.F

22.5 %

BUILDING COVERAGE PROPOSED: 22.33 %

OPEN SPCAE CALCULATIONS:

RESIDENCE: 2nd STORY OVERHANG: SLATE PATIO: COVERED PORCH: WALKWAY: AC PLATFORM: DRIVEWAY:	4,823.3 S.F 563.3 S.F 540 S.F. 405 S.F. 33 S.F. 15 S.F. 3,500.0 S.F.
TOTAL:	9,932.6 S.F
OPEN SPACE REQ.	55%
OPEN SPACE PROPOSED:	<u>65.41%</u>

PERMIT ISSUE OF NEV Dariuse P. Kulinsti eSign:7/16/2021 1:03:00 PROJECT ISSUE **Is/sue Date** SCALE 3/32" = 1'-0" SHEET ISSUE 06/115/21 FORMAT ARCH D SHEET NAME OPEN SPACE **& BUILDING** COVERAGE CALCULATIONS © 2021 DARIUSZ P. KULINSKI -SHEET A108

REV DATE ISSUE

KEY PLAN