ZONING BOARD OF APPEALS APPLICATION

Project Nam	e, If Applicable:Ad	ditions and	alteratio	ns to F	Haller	residence		
Project Stree	et Address: 20 L	ocust Lane						
Section:	7.E Block: _2	Lot(s):	5				Zone:	AA
Applicant:_	John L. Downs, Ard	chitect/Plan	ner LLC	1				
Address:	12 Brookridge Driv	/e						
City:	Greenwich		_State:		<u>CT</u>	Zip:	06830	
Phone #:	203-554-1219		-	Email:		downsarc	hitect@aol.com	
Owner:	John Haller							
Address:	20 Locust Lane							
City:	Bronxville		_State:		NY	Zip: _	10708	
Phone #:	917-576-2201]	Email:_		johnhaller	@gmail.com	
Application i	is for:							
	An interpretation of the	Zoning Law	or a det	erminat	ion by	the Superint	endent of Building	s
X	Area variance(s)(Chapter 310,	Section	19(E)				
	Use Variance					st Sections		
	Special Permit Use				Li	st Sections		
	. —					st Sections		
Description	of the proposed project	and nature	of the	interpr	etatio	n, variance(s) and/or special	permit bei
sought:	Construct 2-1/2 sto	ry addition	to inclu	de an e	expand	led 2nd floo	or bedroom suite a	and a third
	floor recreation roc	m & bathro	om. Inc	rease i	n FAF	R approxima	ntely 10 %	

When did present owner acquire title? _	8/1/2017	
Was the title acquired by purchase: Yes	or No), If so from v	whom?
Are you seeking a variance from the prov	visions of the ordinance	e? (Yes or No)
If so, from which ordinance, from which	provision thereof and t	to what extent?
	_	y; 22.5% allowed - pre-existing non-conforming
Variance Required - 11.93%		
2. Proposed Work - 2-1/2 story additi	on - Proposed Buildin	g Coverage - 34.43% - Non-compliant with
Village of Bronxville Zoning Code	Chapter 310, Section	9 (E) Variance required.
If you are cooking a variance from the pr	ovisions of the ordinan	as do you contand that the offset of the ordinance
•		ce, do you contend that the effect of the ordinanc
		its effect on other properties in the same zoning
district? (Yes or No If so	, in what respect	and what is the cause of the difference
Does the owner of the premises involved	in this annlication own	any contiguous property? (Ves or No)
If so, in what respect and what is the cause		
22 So, 11 What I espect and What Is the each	_	
Owners Signature:	John Haller	Date: _October 4, 2021

Zoning Compliance Analysis

Property Address:	20 Locus	st Lane
Zoning District:	AA	
Flood Zone: Yes:_		No:_X_

ZONING STANDARD	REQUIRED	EXISTING	PROPOSED	STATUS
BUILDING USE	Single family	Single family	Single family	
LOT AREA	15,000 sf	7500 sf	7500 sf	
LOT WIDTH	100'	75'	75'	
LOT DEPTH	100'	100'	100'	
FRONT YARD	35'	27.5'	27.25'	
SIDE YARD #1	15'	10'	10'	
SIDE YARD #2	20'	10.2'	10.2'	
REAR YARD	32'	35'-2"	35'-2"	
HEIGHT (Feet & Stories)	2.5, 30'	2.5, 23'-8-1/2"	2.5, 23'-8-1/2"	
BUILDING COVERAGE	22.5%	32.86%	34.43%	
USABLE OPEN SPACE	55%	57.55%	55.99%	
F.A.R.	3150 sf	2541 sf	2854 sf	
PARKING	2 cars	2 cars	2 cars	

Form Prepared By:	Name (Print):	John Downs AIA		
If yes, describe all add	litional variances:			
•	uired (or were any vari _XNo	ances approved by the	e ZBA) that are not lis	ted on the table
* *	ditions to submit comporksheet on reverse, su	L	C	

Zoning F.A.R. Calculation

	EXISTING	PROPOSED	SUB TOTAL
BASEMENT ^(b)	0	0	0
1 ST FLOOR	1557	0	1557
2 ND FLOOR	1267	313	1580
3 RD FLOOR (d)	0	0	0
ATTIC (d)			
GARAGE (c)	283	0	(283) credit
			, ,
ACT	UAL TOTAL BUILDI	NG FLOOR AREA =	2854
	AC	ΓUAL LOT AREA =	7500
PERMITTED F.A	.R. (From Table, inter	polate if necessary) =	.42
	ERMITTED BUILDI LOT AREA X PER		3150

Floor Area Ratio (for a lot whose principal use is a one or two family dwelling): The ratio of the gross floor area of all buildings on a lot to the area of the lot on which the buildings are located. For the purpose of determining the floor area ratio (FAR), all floor areas of each floor of all principal and all accessory structures on the lot shall be included. Any interior space with a floor-to-ceiling height in excess of 14 feet shall be counted twice. Notwithstanding the preceding the following shall be excluded from the calculation of floor area:

- a) The aggregate area of all unroofed structures such as decks and patios and all spaces in unenclosed porches and porticos, except that existing unenclosed porches may be enclosed and the enclosed area excluded from the FAR calculation provided that the exterior walls of the unenclosed porch and the walls of the dwelling to which the porch is attached are not relocated closer to the lot lines of the subject property than the existing unenclosed porch.
- b) The aggregate area of any cellar regardless of its use or of any basement unless it is defined as a story. See Basement definition.
- c) The aggregate area of grade level garage parking (whether attached or detached) or basement level parking, in either case, up to a maximum of 400 square feet. In those instances where an additional story is provided above a garage (whether attached or detached) such floor area shall be subject to the attic and sloping roof limitations in (d) below.
- d) The aggregate area of all unfinished or finished space in an attic or under a sloping roof provided that the total exterior width of all dormers does not exceed 30% of the exterior linear width of the portion of the roof upon which they are situated. The exterior linear width of the roof shall be measured from end to end at the widest point of the roof. Where the linear width of the dormers exceeds the limitation above, the total area in the attic or under the sloping roof shall be included in the calculation of FAR, except where floor area between the top of the floor beams and the structural ceiling level is five (5) feet or less.

Calculations Prepared By:	Name (Print):	John Downs AIA
	Signature:	John Downs
	0	

VILLAGE OF BRONXVILLE Department of Buildings 200 Pondfield Road (914) 337-7338 (914) 337-0158 (Fax)

PLAN REVIEW COMMENTS

APPLICATION NUMB:

ALT 132-21

DATE RECEIVED:

June 30, 2021

LOCATION:

20 Locust Lane

SBL:

7.E/2/5

APPLICANT NAME:

O'Brien Carpentry Inc.

APPLICANT ADDRESS:

12 Red Mills Road

Mahopac, NY 10541

DESCRIPTION OF WORK:

Construct 2 1/2 story addition to include an expanded 2nd

floor bedroom suite and a third floor recreation room & bathroom.

DISAPPROVED September 28, 2021, FOR THE FOLLOWING:

Your revised application for a permit on the above location has been reviewed and a permit may not be issued at this time for the reasons indicated below.

ZONING CODE REVIEW (Section Numbers refer to Village Code of 1981)

Zoning Review -

ALT 132-21

- 1) Existing conditions Building Coverage existing 32.86%; 22.5% allowed pre-existing non-conforming Variance Required 11.93%
- 2) Proposed Work 2-1/2 story addition Proposed Building Coverage 34.43% Non compliant with Village of Bronxville Zoning Code Chapter 310, Section 9 (E) Variance required -

This document constitutes a final administrative determination by the Building Inspector denying your application for the reasons set forth above. Section 7-712(a) of the New York State Village Law provides that any appeal of this decision must be filed within 60 days of the date hereof with the Zoning Board of Appeals of the Village of Bronxville.


PLAN REVIEW

Plan Review - This will be performed upon approval of zoning variance.

Paul Taft

Building Inspector

CC: Haller, John

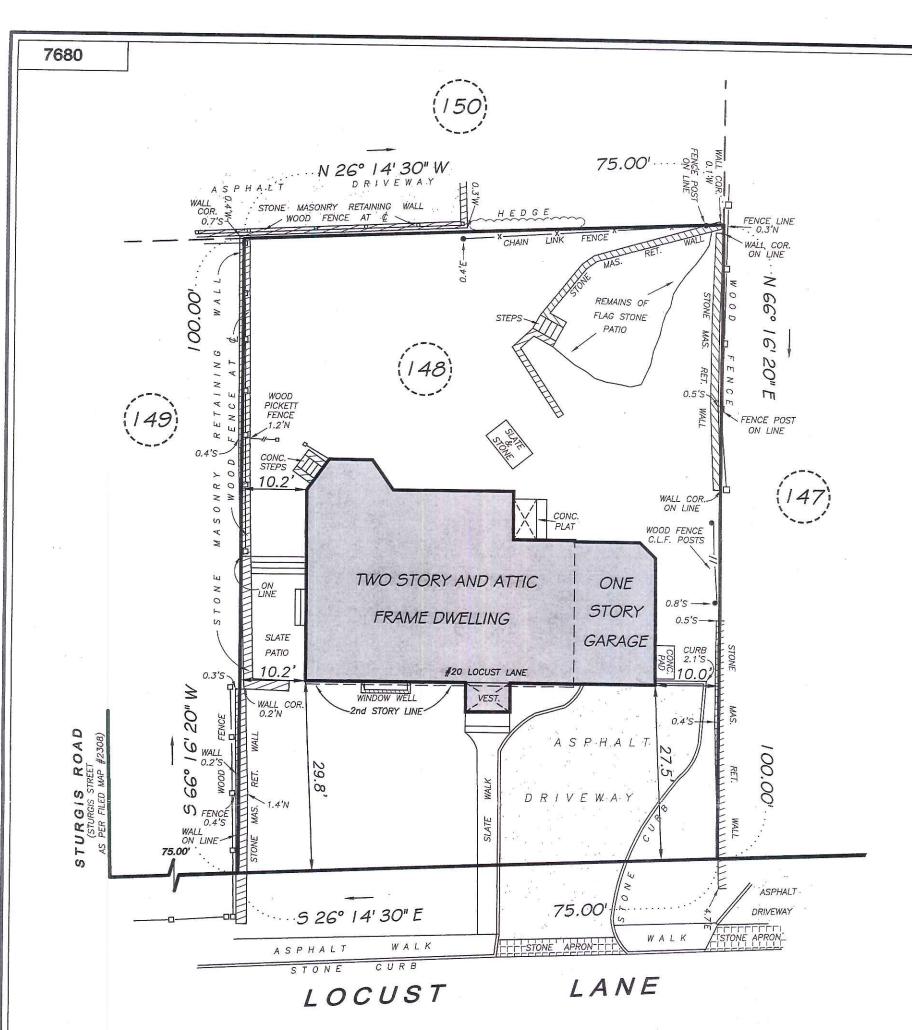

- THE PREMISES SHOWN HEREON DESIGNATED AS LOT No. 148 ON A CERTAIN MAP ENTITLED "MAP OF SUNNY BRAE, PROPERTY OF WINIFRED MASTERSON BURKE RELIEF FOUNDATION, FRONTING ON WHITE PLAINS ROAD, PONDFIELD ROAD AND LOCUST LANE, SITUATE IN MOUNT VERNON AND BRONXVILLE, WESTCHESTER COUNTY, N.Y. ", DATED APRIL 27, 1921, SURVEYED BY EARL B. LOVELL, CIVIL ENGINEER AND CITY SURVEYOR, AND FILED IN THE OFFICE OF THE WESTCHESTER COUNTY CLERK DIVISION OF LAND RECORDS, FORMERLY THE REGISTER'S OFFICE OF WESTCHESTER COUNTY ON JUNE 2, 1921 AS FILED MAP No. 2308
- PREMISES ARE DESIGNATED ON THE TAX MAPS FOR THE VILLAGE OF BRONXVILLE / TOWN OF EASTCHESTER SECTION 7E; BLOCK: 2; LOT: 5 PROPERTY AREA: 7,500 SQ. FT. / 0.1722 AC. STREET ADDRESS: 20 LOCUST LANE
- THIS MAP IS BASED UPON THE INFORMATION SUPPLIED BY THE CLIENT AND/OR HIS REPRESENTATIVE AND SUBJECT TO THE FINDINGS THAT A COMPLETE ABSTRACT OF TITLE MAY UNCOVER
- THE OFFSETS SHOWN HEREON ARE NOT INTENDED TO ESTABLISH PROPERTY LINES FOR THE ERECTION OF FENCES, STRUCTURES OR ANY OTHER IMPROVEMENTS.
- ENCROACHMENTS BELOW GRADE AND/OR SUBSURFACE FEATURES, IF ANY, NOT LOCATED OR SHOWN HEREON.
- UNAUTHORIZED ALTERATION OR ADDITION TO A SURVEY MAP BEARING A LICENSED LAND SURVEYOR'S SEAL IS A VIOLATION OF SECTION 7209, SUBDIVISION 2, OF THE NEW YORK STATE EDUCATION LAWS.
- THE INFORMATION DEPICTED HEREON IS BASED UPON AN ACTUAL FIELD SURVEY AND IS AN OPINION BASED UPON SAID SURVEY. VARIATIONS IN OFFSETS FROM THAT OF THE OTHERS CAN AND MAY EXIST.
- ONLY COPIES FROM THE ORIGINAL OF THIS SURVEY MARKED WITH AN ORIGINAL OF THE LAND SURVEYOR'S SEAL SHALL BE CONSIDERED TO BE TRUE VALID COPIES.
- THIS MAP WAS PREPARED FROM AN ACTUAL FIELD SURVEY CONDUCTED ON THE DATE SHOWN AND THAT SAID SURVEY WAS PERFORMED IN ACCORDANCE WITH THE EXISTING " CODE OF PRACTICE FOR LAND SURVEYS" ADOPTED BY THE NEW YORK STATE ASSOCIATION OF PROFESSIONAL LAND SURVEYORS.

PREPARED FOR: NORMAN GRETZINGER


SURVEY OF PROPERTY SITUATE IN THE VILLAGE OF BRONXVILLE TOWN OF EASTCHESTER WESTCHESTER COUNTY

NEW YORK

SCALE : 1"= 15" SURVEYED : NOVEMBER 16, 2016



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ZONING COMPLIANCE ANALYSIS

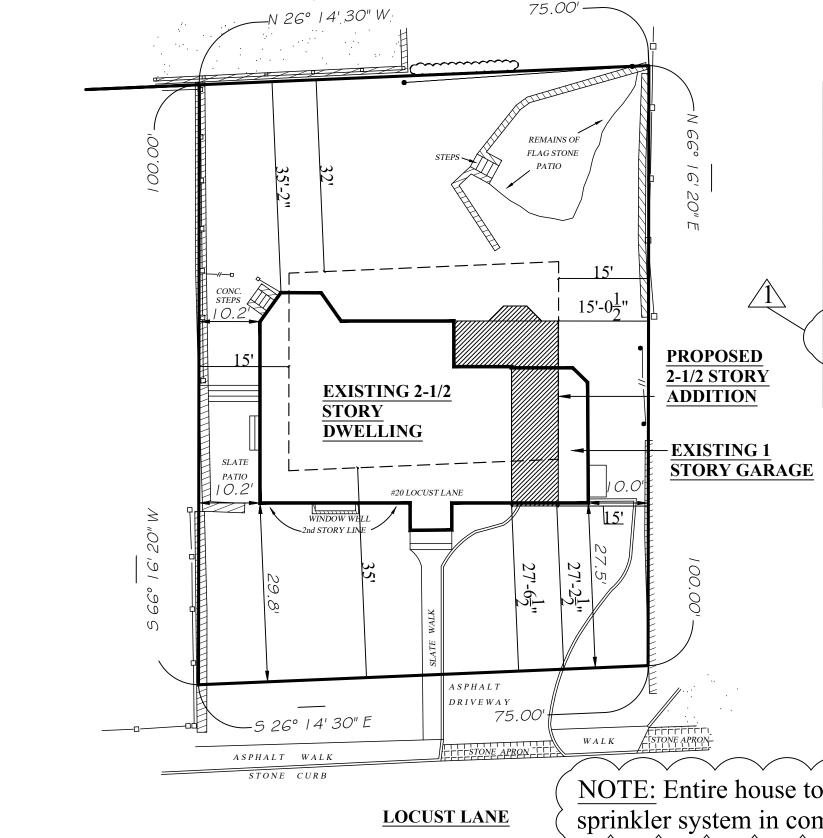ZONING STANDARD	REQUIRED	EXISTING	PROPOSED
BUILDING USE	RESIDENTIAL	RESIDENTIAL	RESIDENTIAL
LOT AREA	15,000 SF	7,500 SF	7,500 SF
LOT WIDTH	100'	75'	75'
LOT DEPTH	120'	100'	100'
FRONT YARD	35'	27.5'	27.25'
SIDE YARD	15'	10.0'	10.0'
SIDE YARD	20'	10.2'	10.2'
REAR YARD	32'	35'-2"'	35'-2"'
HEIGHT (feet and stories)	30', 2.5 TORIES	23'-8-1/2", 2.5 STORIES	23'-8-1/2", 2.5 STORIES
BUILDING COVERAGE	22.5% MAX	32.86%, 2,465 sf	34.43%, 2,582 sf
USABLE OPEN SPACE	55% MIN	57.55% , 4,316 sf	55.99% , 4199 sf
F.A.R.	0.42, 3,150 sf	0.3388, 2,541 sf	0.3805, 2,854 sf
PARKING	2	2	2

OCCUPANCY CLASSIFICATION:

Single Family Residential

CONSTRUCTION CLASSIFICATION: Type 5B, Frame Construction

ENERGY CODE COMPLIANCE STATEMENT:

I, John L. Downs, certify that to the best of my knowledge, belief and professional judgement these plans are in compliance with the New York State Energy Conservation Code.

Design Requirements for The Residential Code of New York State Village of Bronxville, NY

GROUND		WINI	DESIGN		SEISMIC	SUBJECT	TO DAMAGE	FROM	WINTER	ICE	FLOOD	AIR	MEAN
LOAD	Speed ^d (mph)	Topographic effects ^k	Special wind region	Wind-borne debris zone ^m	DESIGN CATEGORY	Weathering*	Frost line depth ^b	Termite ^c	DESIGN TEMP*	BARRIER UNDERLAY- MENT	HAZARDS ²	FREEZ ING INDEX	ANNUAL TEMP
30 PSF	115	No	No	No	С	Severe	42"	Mod To Heavy	15 DEG	Yes	a) 3/11/96 b) 9/28/07 Flood Insurance Study c) Panel Numbers & Dates of current FIRMS & FIEM's, Amendments 36119C0329F – 9/28/07	618	52.2

NOTE: Entire house to be equipped with residential sprinkler system in compliance with NFPA 13

ZONING INFORMATION:

RESIDENCE AA

7.E

No

1. All work to comply with applicable state and local codes, including the 2020 NY State Uniform Code - Residential

Code, including reference to Appendix J as applicable. 2. Owner shall pay for all Surveyor and building permit

3. All dimensions are given to rough surfaces, face of studs, block or concrete walls, or top of sub-floor, unless

5. Notify Architect immediately of any discrepancies between the plans and field conditions. No extras will be

accepted without prior review & approval. 6. The Contractor shall be responsible for temporary shoring and bracing required to maintain the structural

stability of the building during construction. 7. Protect all wood floors/tile floors during Construction. If damaged, floors to be replaced at no expense to Owner. 8. All sections and details shown shall be considered typical

9. An asbestos survey shall be conducted prior to

notified if asbestos is removed, and prior to all

otherwise specifically noted.

government regulations.

can be field verified.

and apply for the same, and similar conditions, unless

demolition or renovation. Government agencies shall be

demolitions. Remove and dispose of asbestos as per

Compensation and Liability Insurance in force prior to

11. Those items not specified on the drawings, but implied as

12. All work is to be performed by mechanics skilled in their

13. The Contractor shall guarantee all work for a period of one year in accordance with AIA General Conditions. 14. These drawings are issued for building permit only.

Contractor will be issued a set stamped for construction

once demolition begins and existing framing conditions

necessary as part of the work shall be considered a part

10. The Contractor shall provide evidence of Workman's

Zoning District:

otherwise noted. 4. Do not scale drawings.

GENERAL REQUIREMENTS

Section: Block#: Lot#: Flood Zone:

Revised 09-13-2021

Khristan and John Haller

JOHN L. DOWNS


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Additions & Alterations to Haller Residence 20 Locust Lane

Bronxville, NY


05-23-2021 1/16" = 1'-0"

Proposed Site Plan

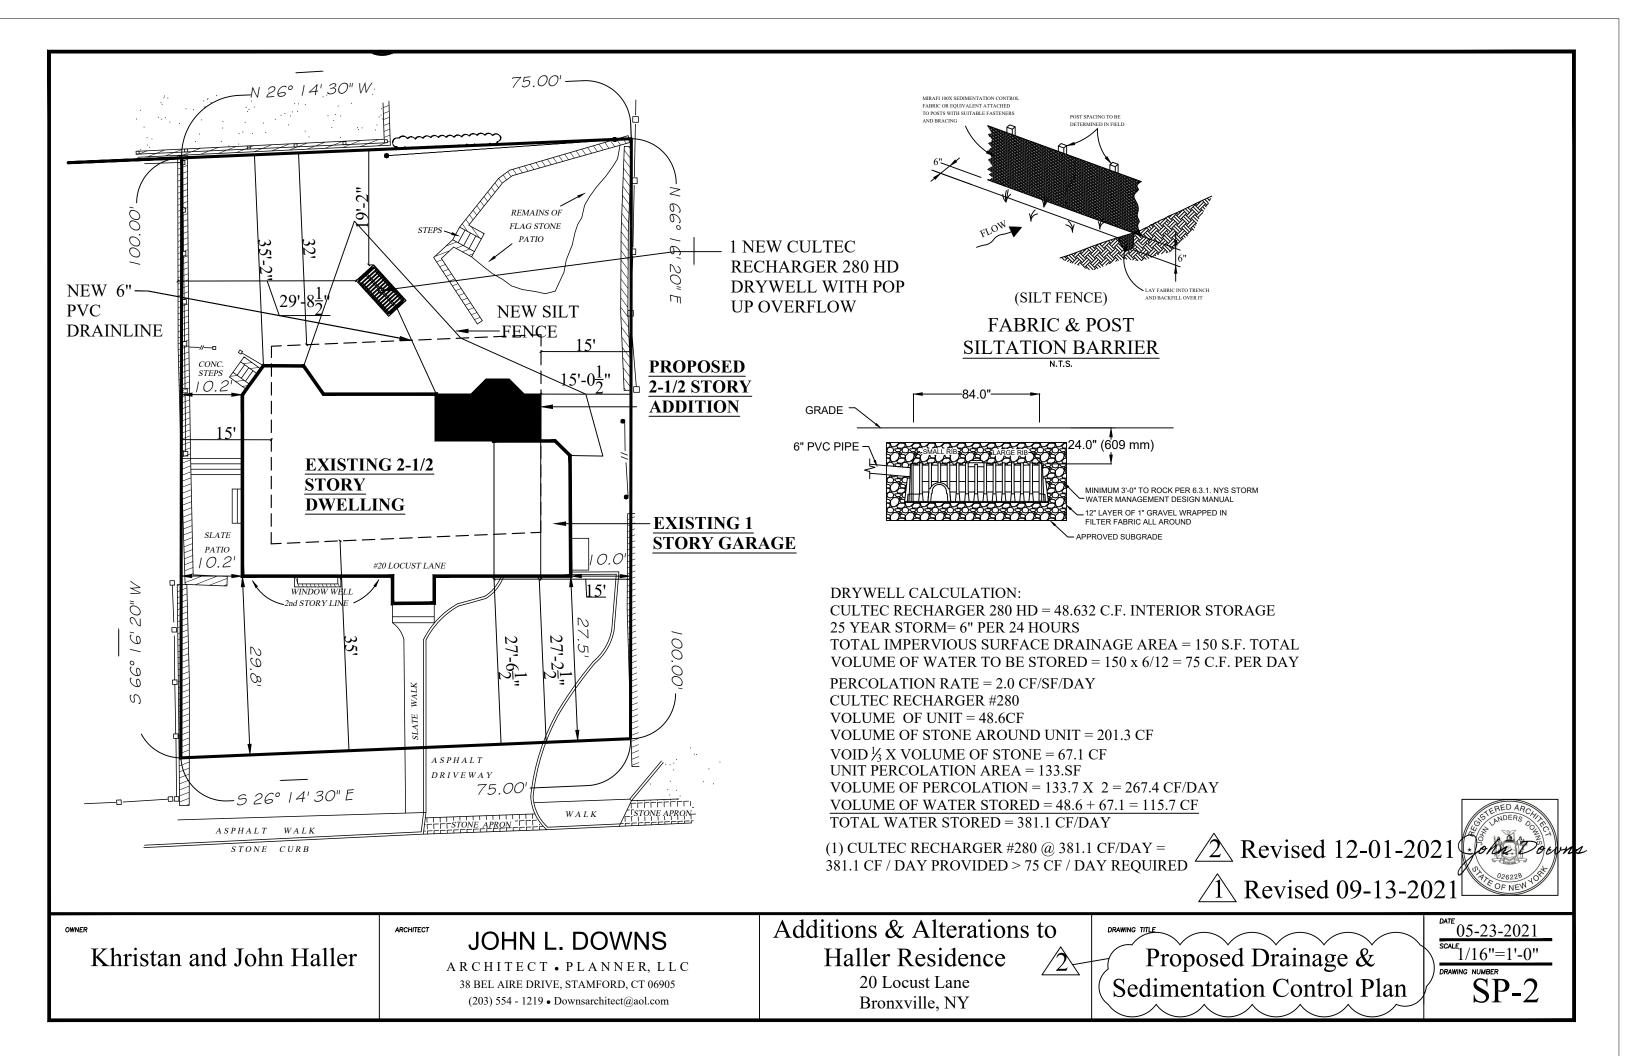

Zoning Compliance Worksheet – District 'AA'

Bronxville District 'AA'	District	Height	Stories	Lot Area	Lot Width	Lot Depth	Front Yard	Side Yard with Garage	Side Yard without Garage	Side Yard corner lot with garage	Side Yard Corner Lot without garage	Side Yard w/ alternative with a garage	Rear Yard	Fence > than 6-1/2' H	ACC Building -	Max Building coverage	Off street parking	FAR	Open space
Bronxville District 'AA' Description of Bulk Requirements	AA	30' mean Height	2-1/2	15000 sf	100'	120'	35'; alternative a) & b)	15'/ 35' min one side/ total 2 sides	27'/ 42' one side/ total 2 sides	30'/ 15' side opp primary front/ other side	30'/ 27' side opp primary front/ other side	deduct 5'	32'	Same as building	No closer than front of principal building, planning may issue special permit	22.5%	2 cars		55%
310-09 Code Section- https://ecode360.com/9450530		310-9B	310-9B	310- 9C	310- 9C	310- 9C	310-9D	310- 9D(2)	310- 9D(2)	310- 9D(2)	310- 9D(2)	310-9D(2)	310- 9D(3)	310- 9D(4)	310- 9D(5)	310-9E	310-9F	310- 9G; 310- 22E	310- 9H
Property Address: 20 Locust Lane																			
Allowed	AA	30'	2.5 stories	15000 sf	100'	120'	35'	15'/ 35'	27'/ 42'	30'/ 15'	30'/ 27'		32'			22.5%	2 cars	3150	55%
Existing	AA	23'-8-1/2'	2.5	7500	75'	100'	27.5'	10'/20.2'					35'-2"			32.86%	2 cars	2541	57.55%
Proposed	AA	23'-8-1/2"	2.5	7500	75'	100'	27.25'	10'/20.2'					35'-2"			34.43%	2 cars	2854	55.99%
Variance required = (proposed - allowed)							Yes									Yes			

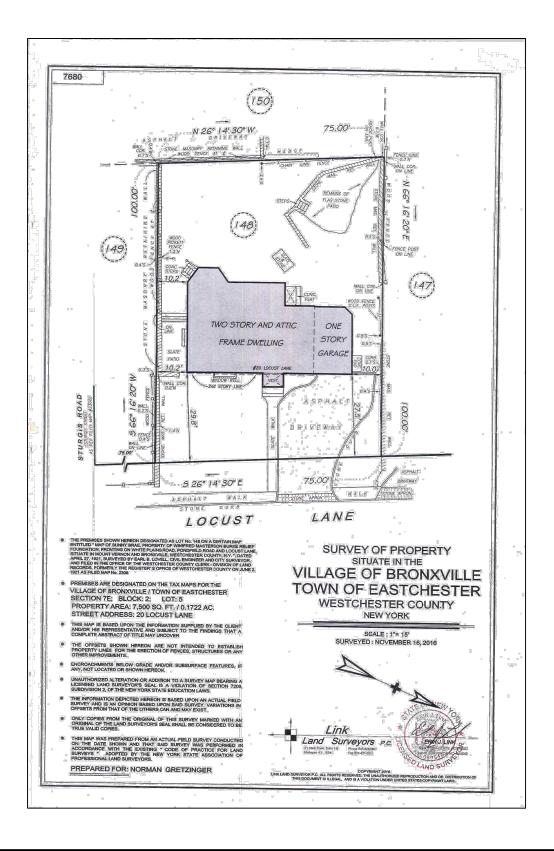



Khristan and John Haller

TECT IC

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Bronxville, NY

DRAWING TITLE

Existing Conditions Site Plan

05-23-2021 SCALE


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EXSP-1










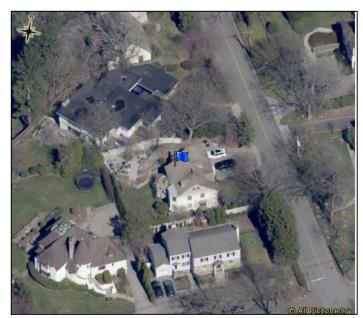

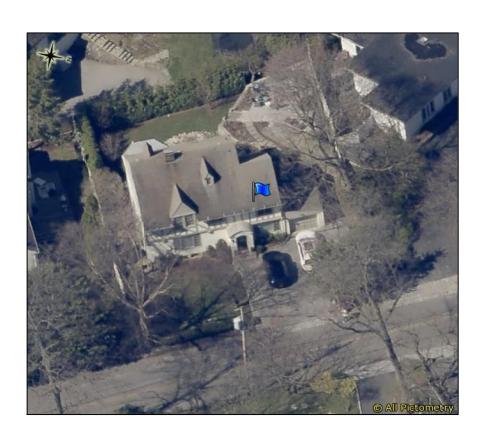



WNER

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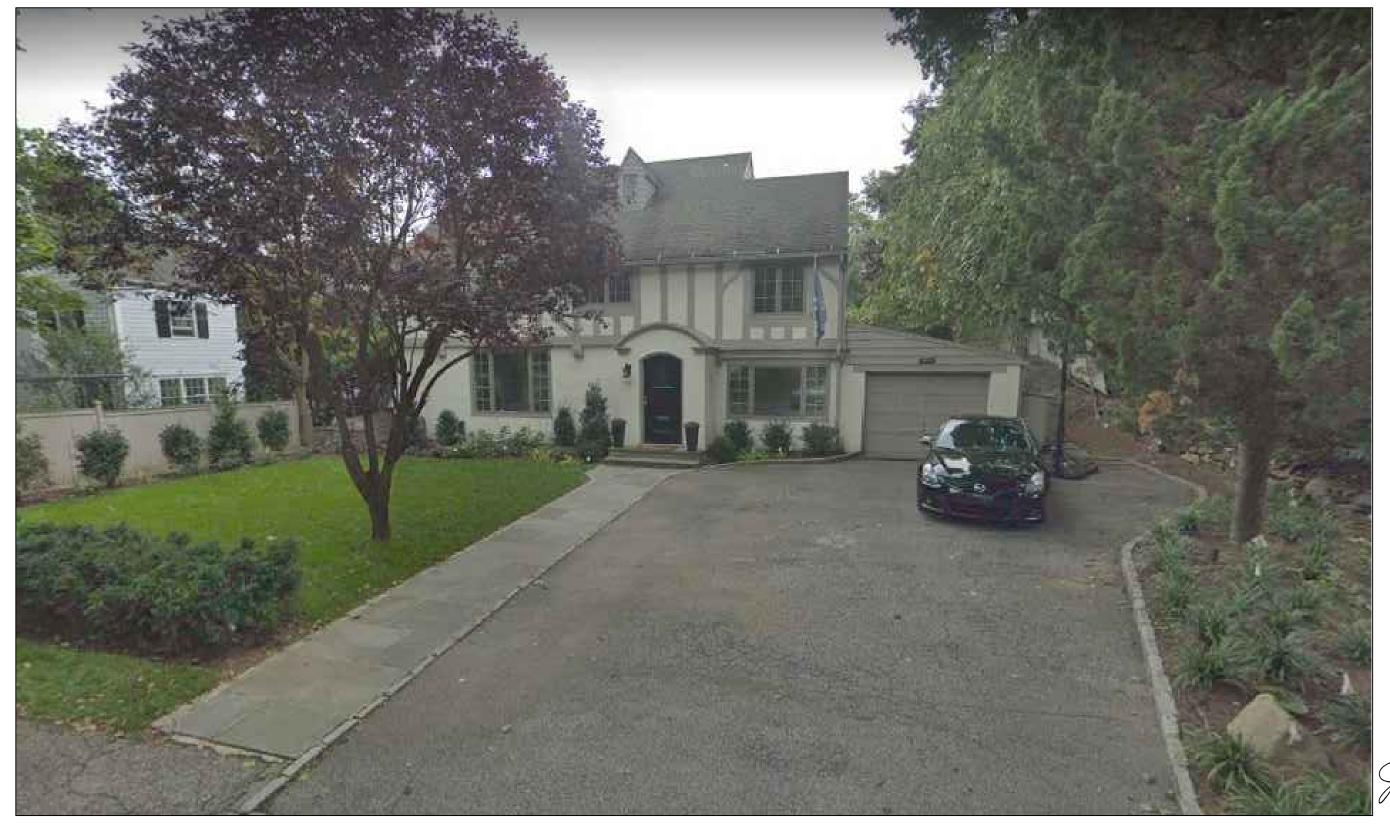
Additions & Alterations to Haller Residence 20 Locust Lane Bronxville, NY

RAWING TITLE

Existing Conditions Photographs 05-23-2021 scale

DRAWING NUMBE

P-1





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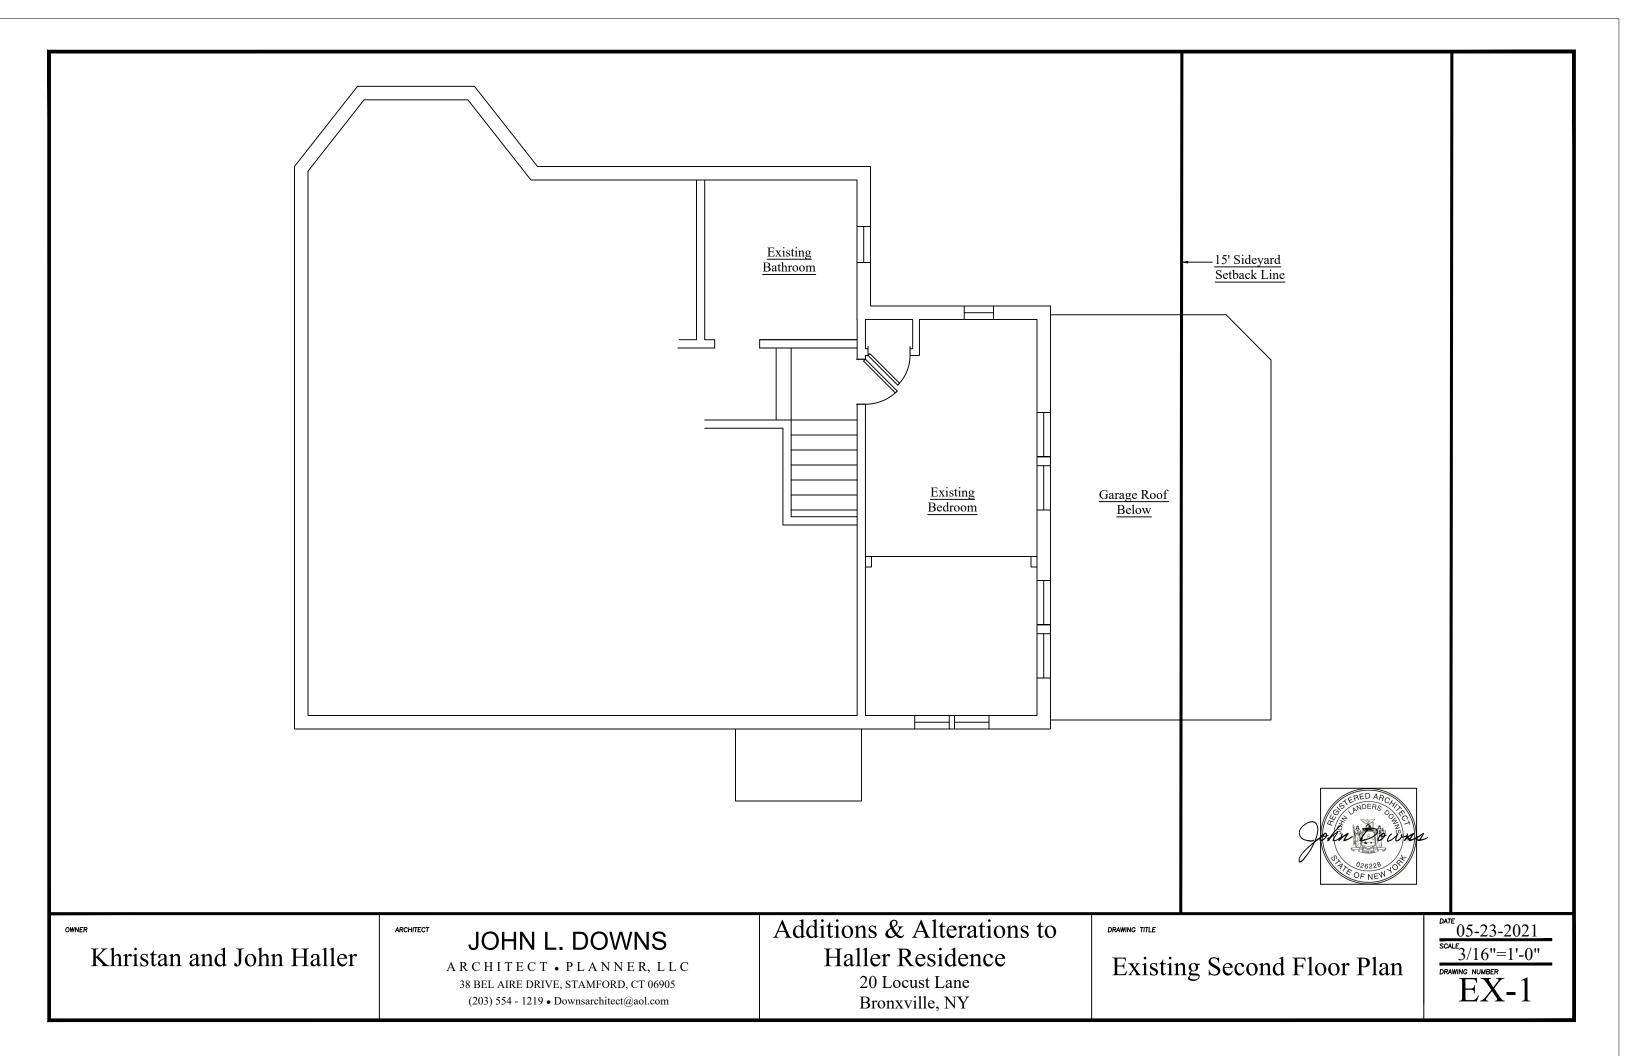
Additions & Alterations to Haller Residence


20 Locust Lane Bronxville, NY


Existing Conditions Photographs

05-23-2021 SCALE

P-2



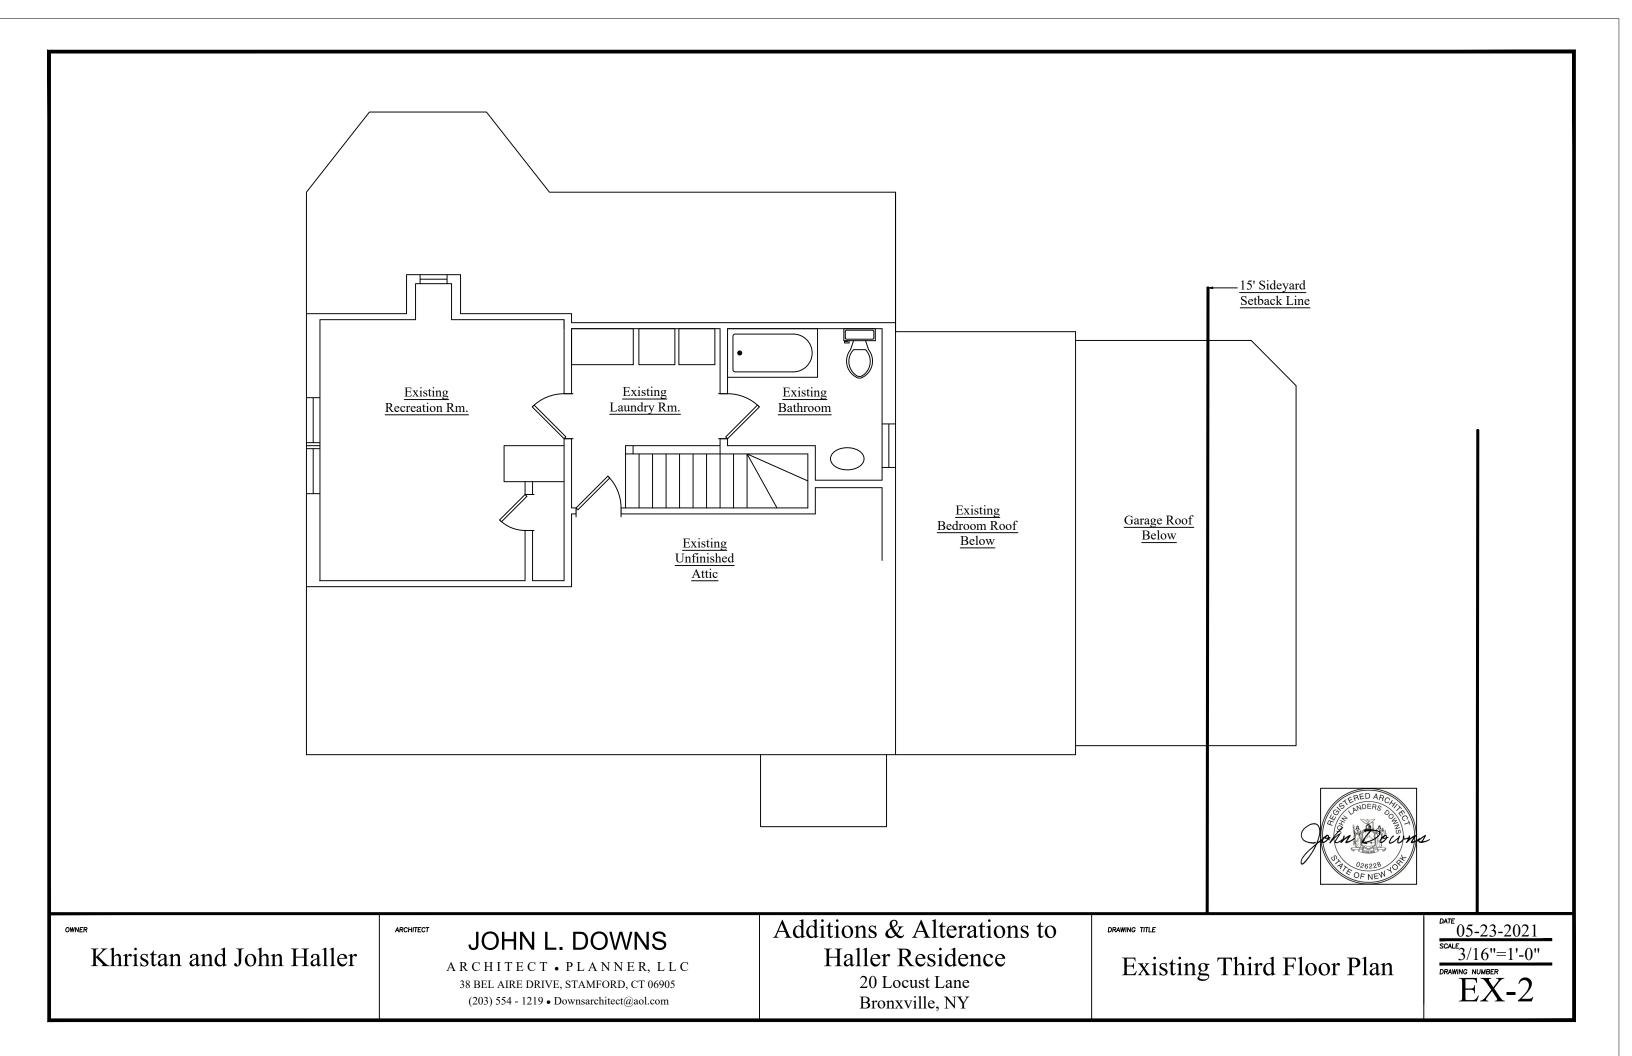

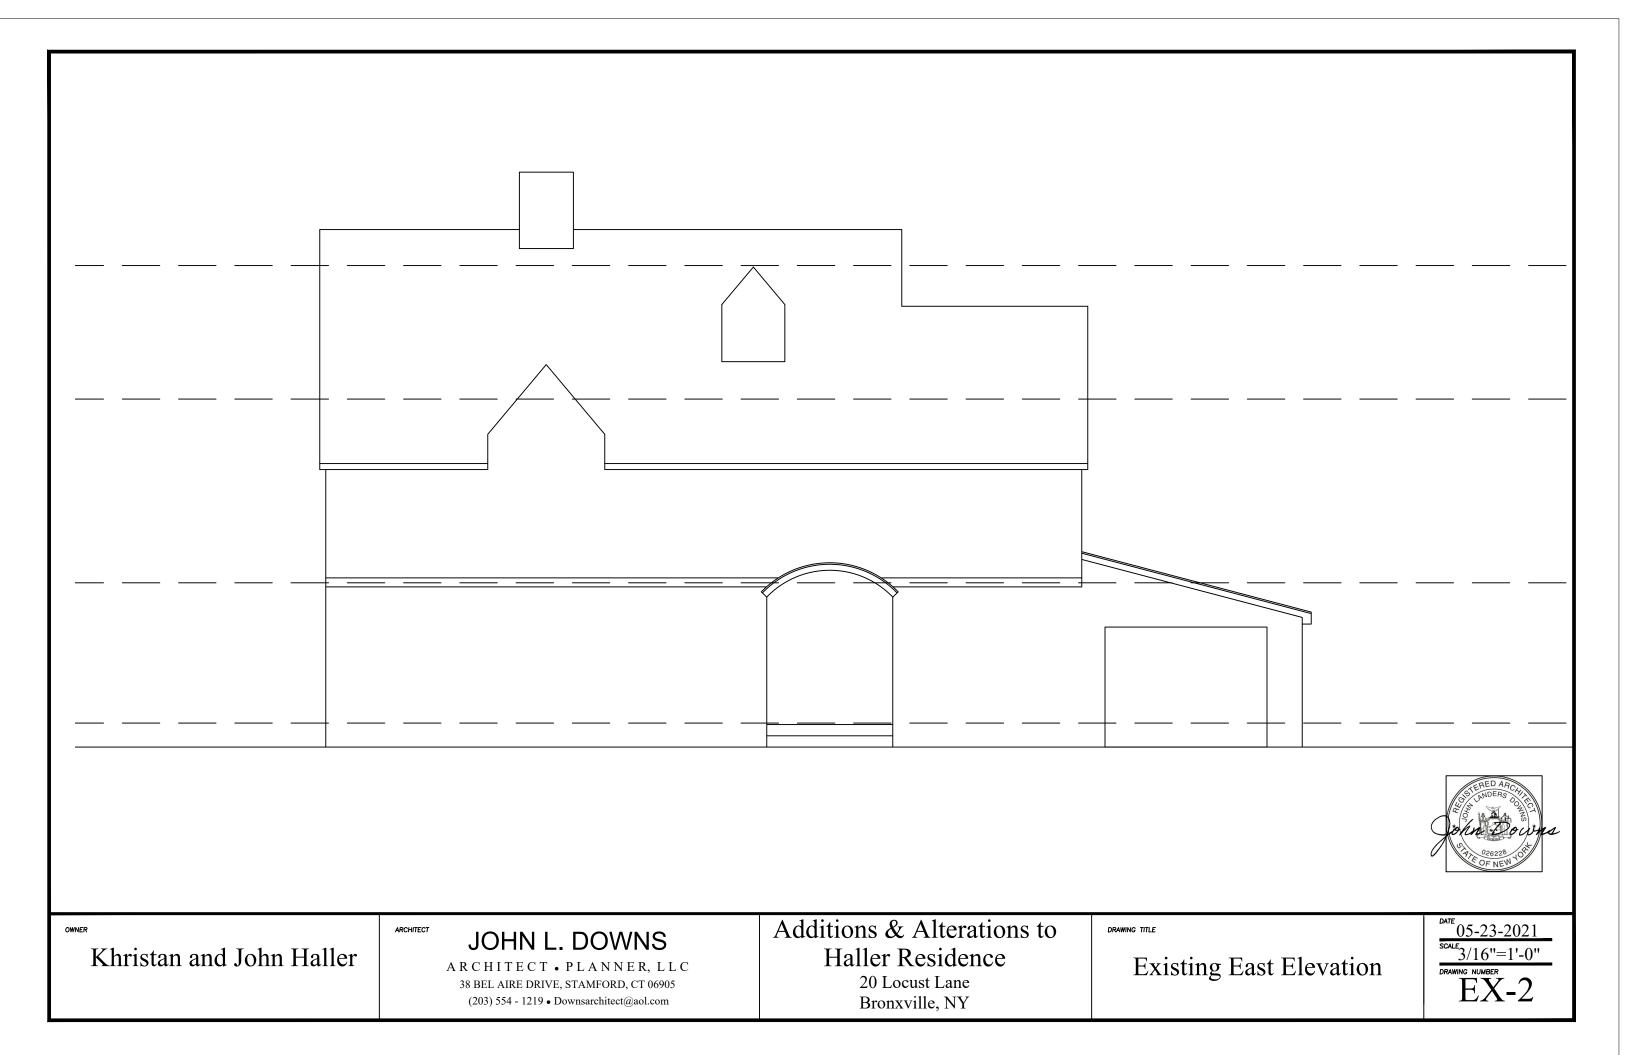





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Additions & Alterations to Haller Residence 20 Locust Lane

Bronxville, NY


Existing North Elevation

05-23-2021

SCALE 3/16"=1'-0"

DRAWING NUMBER

EX-3

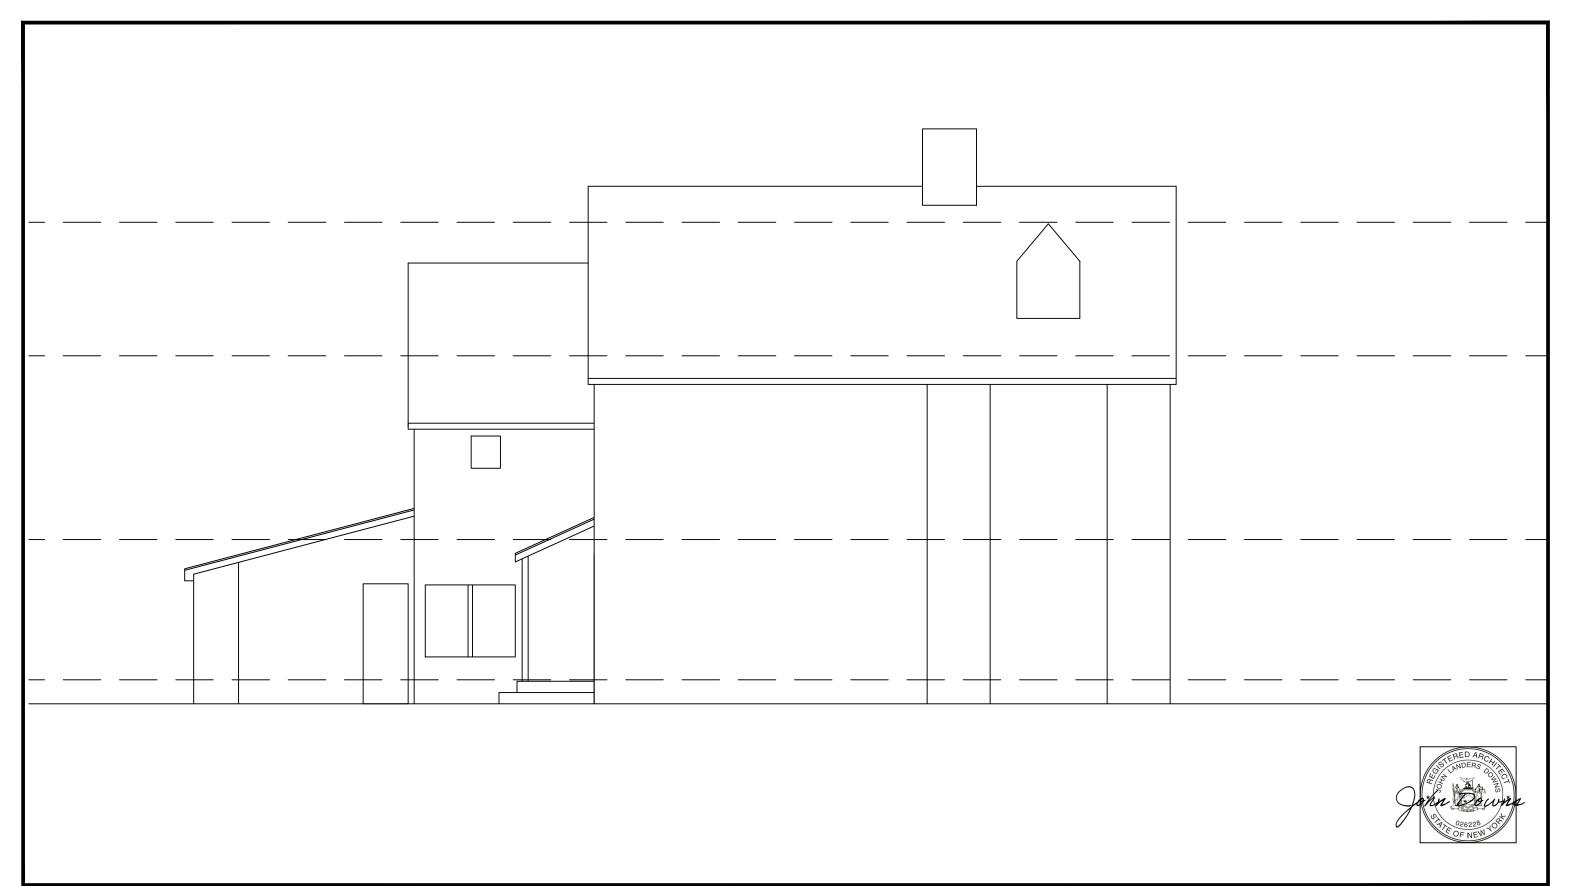

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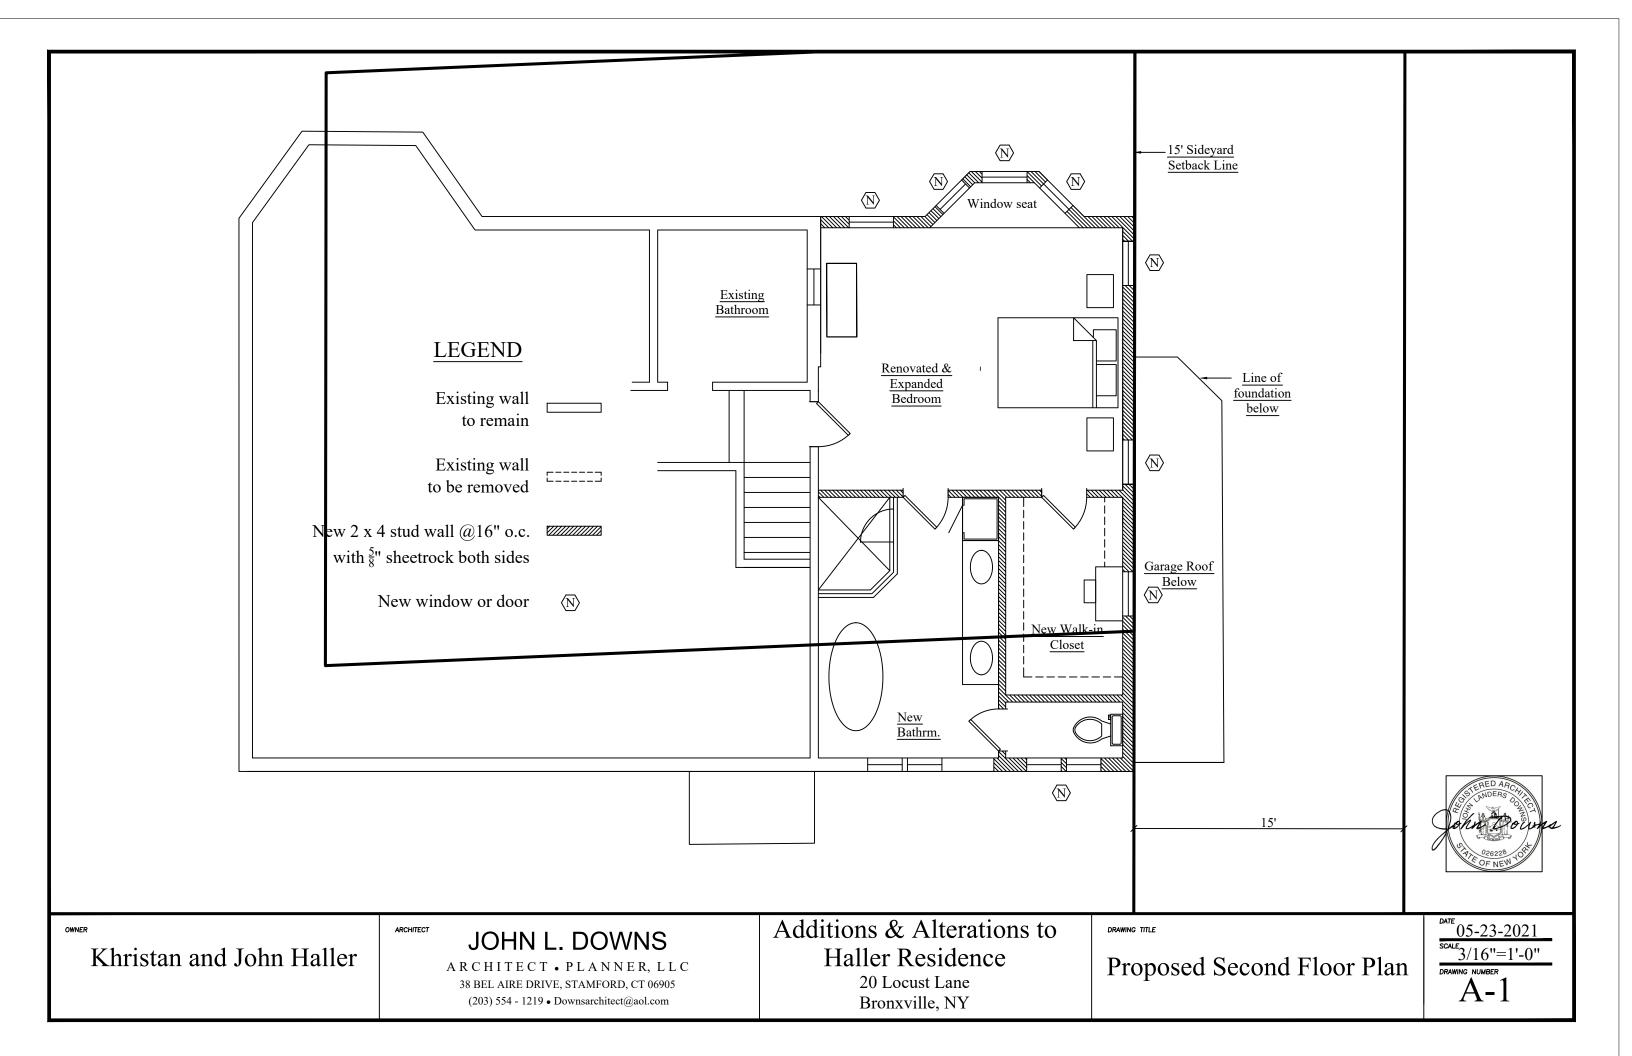
Existing West Elevation


05-23-2021


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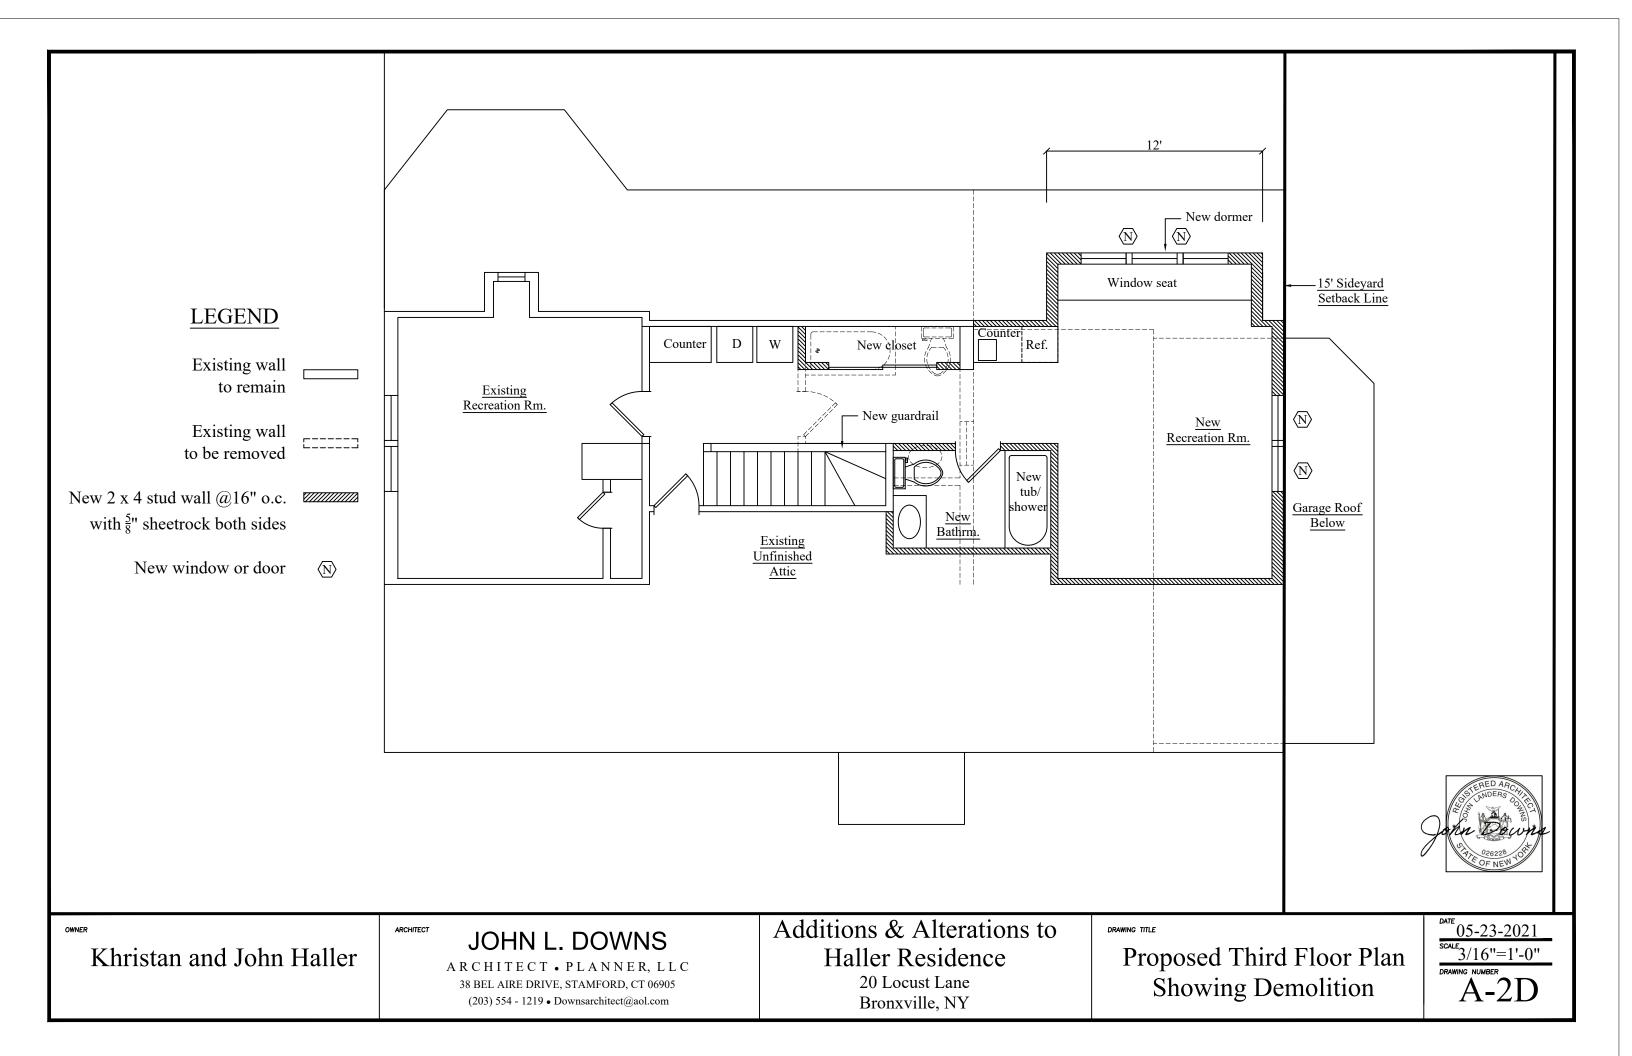
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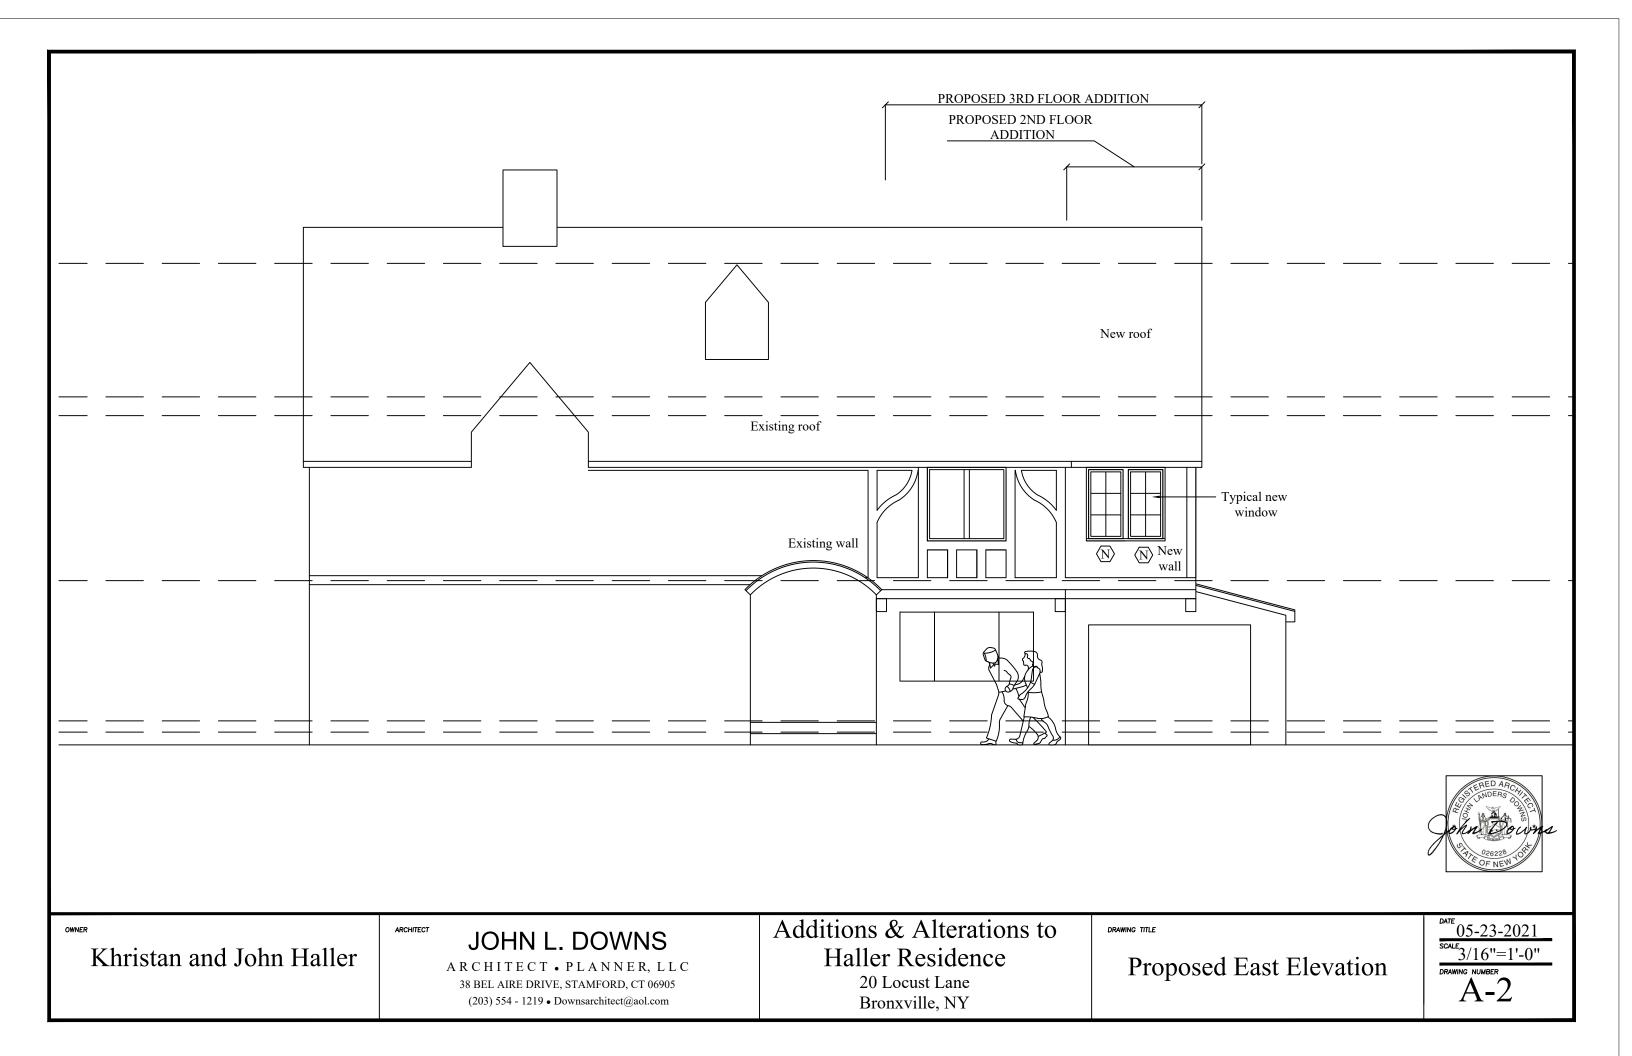
EX-4










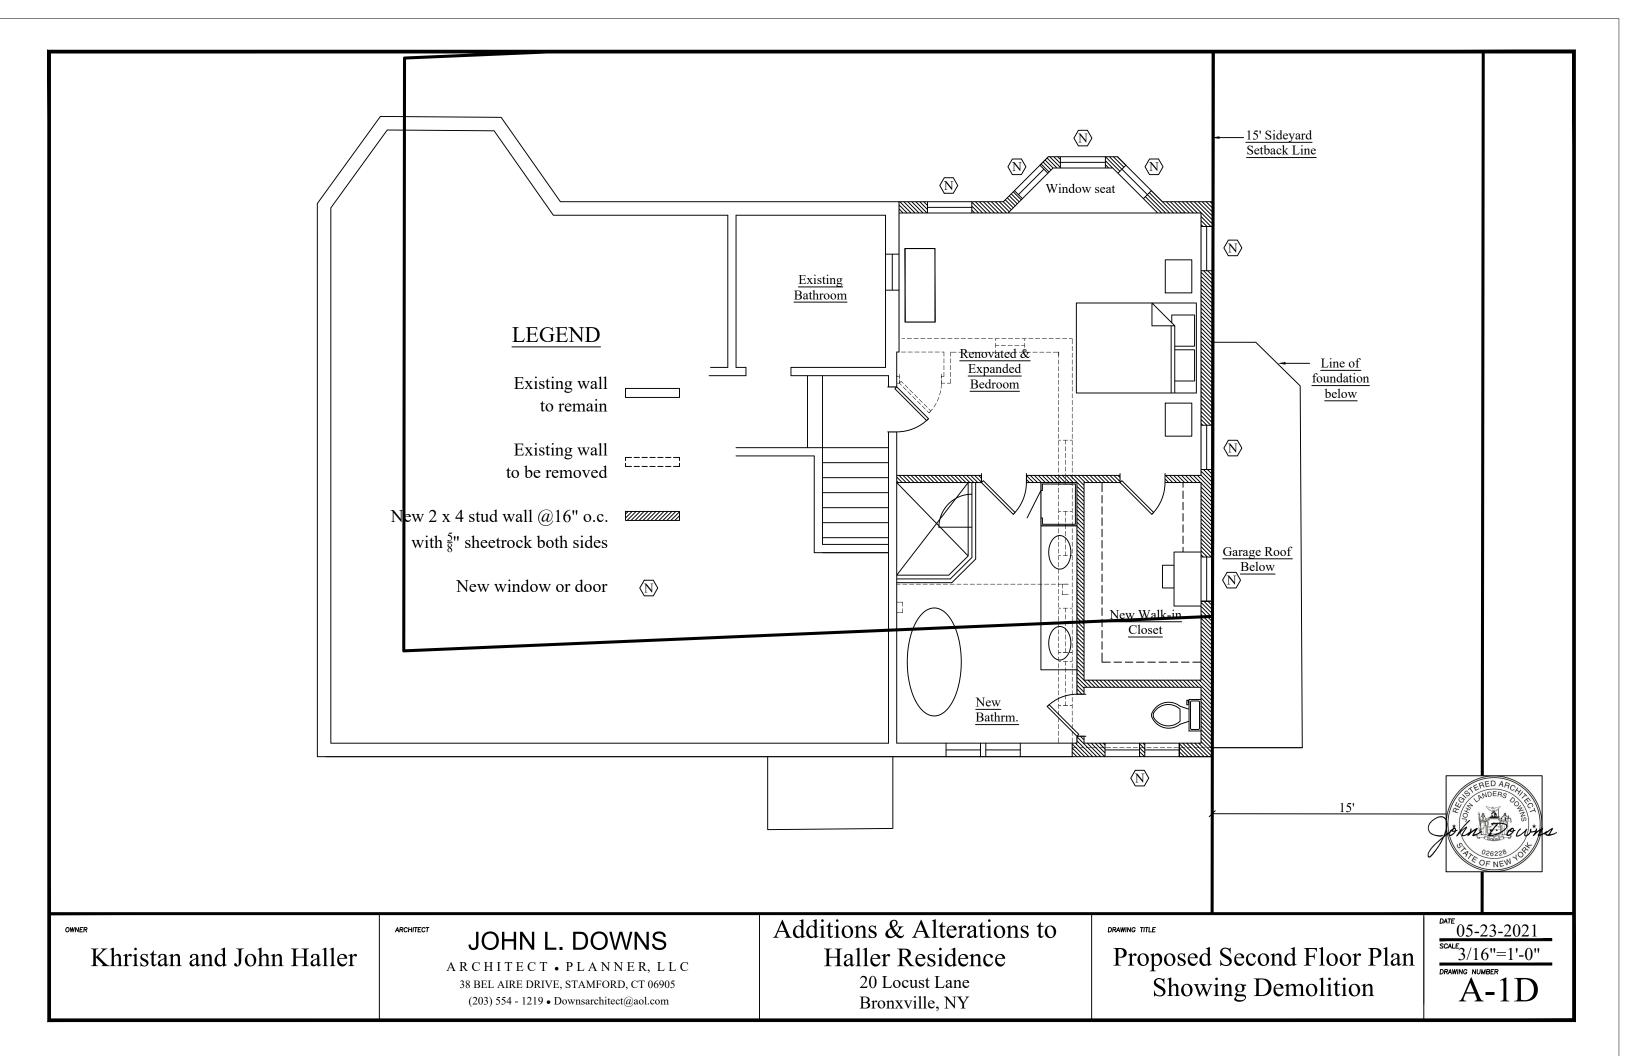


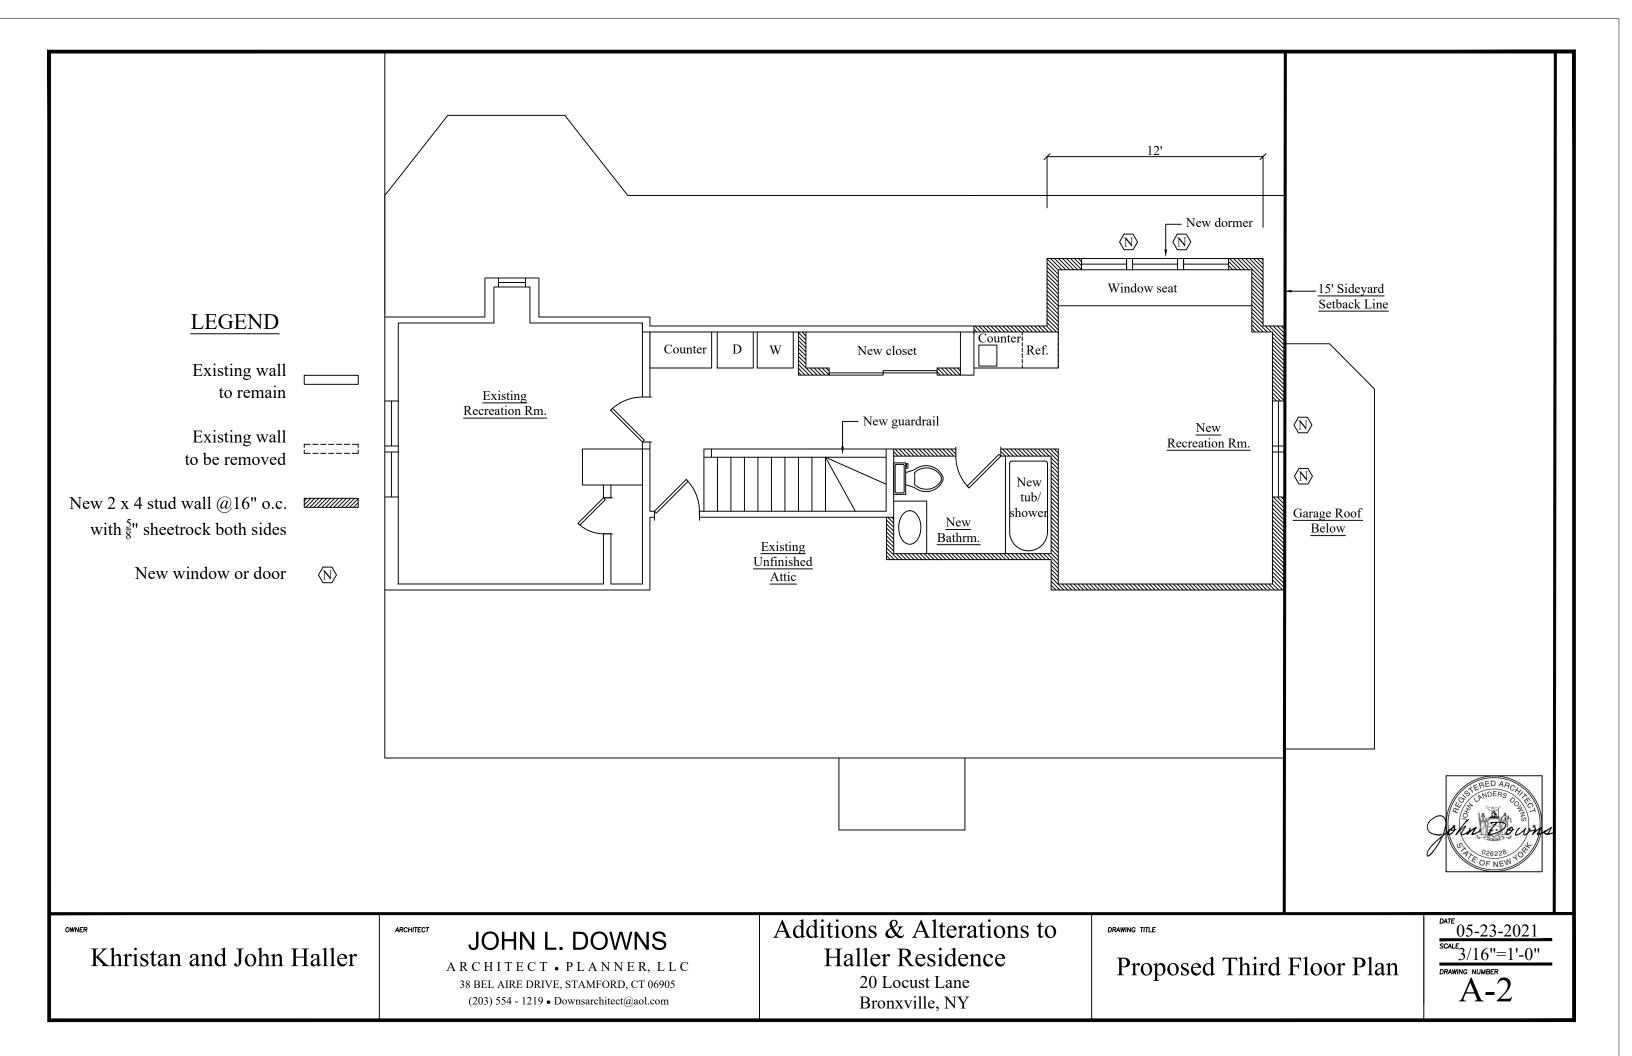

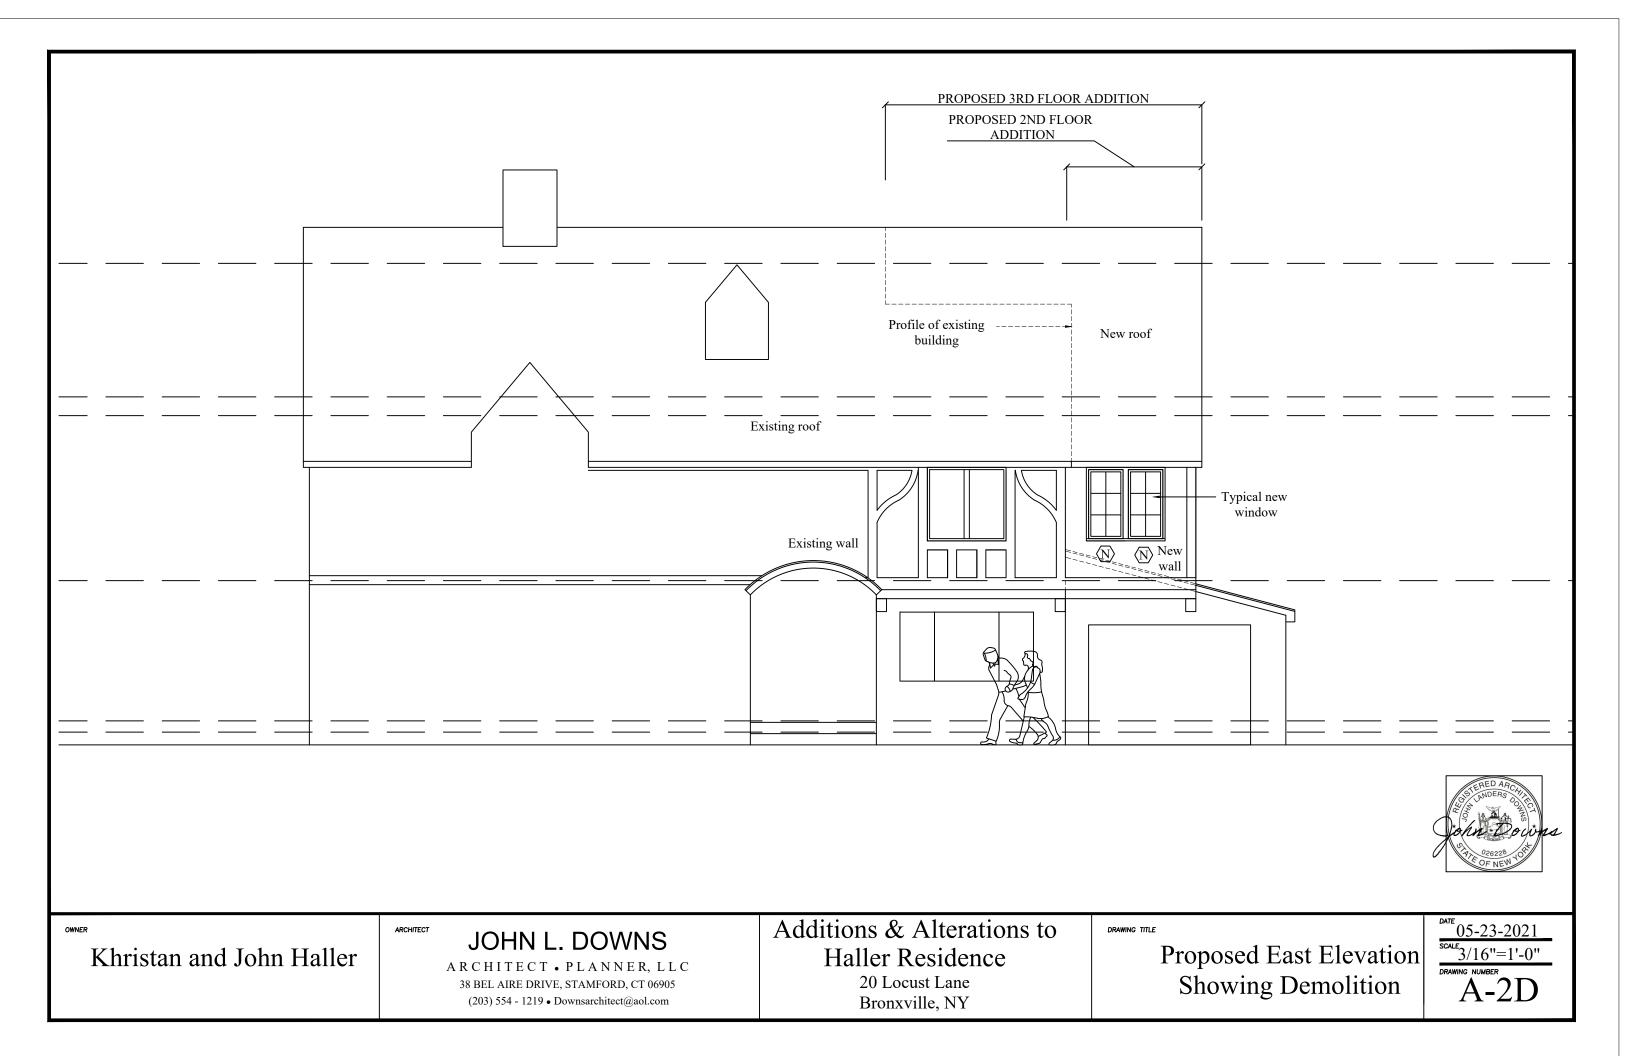

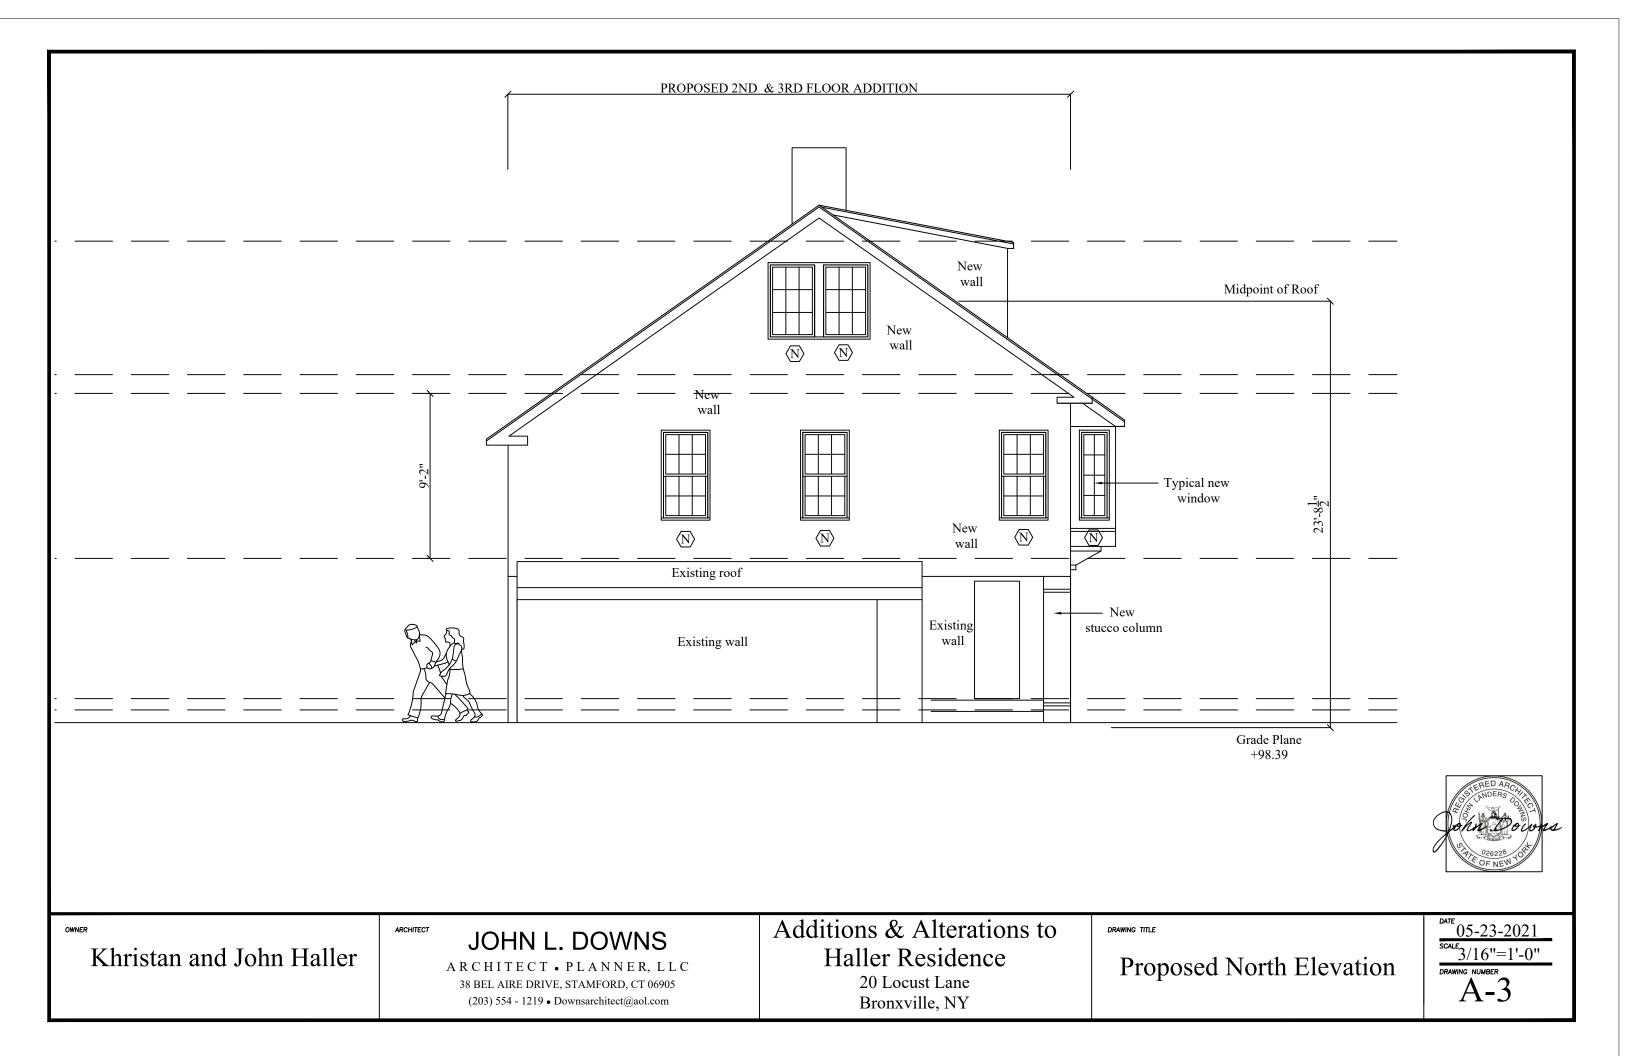

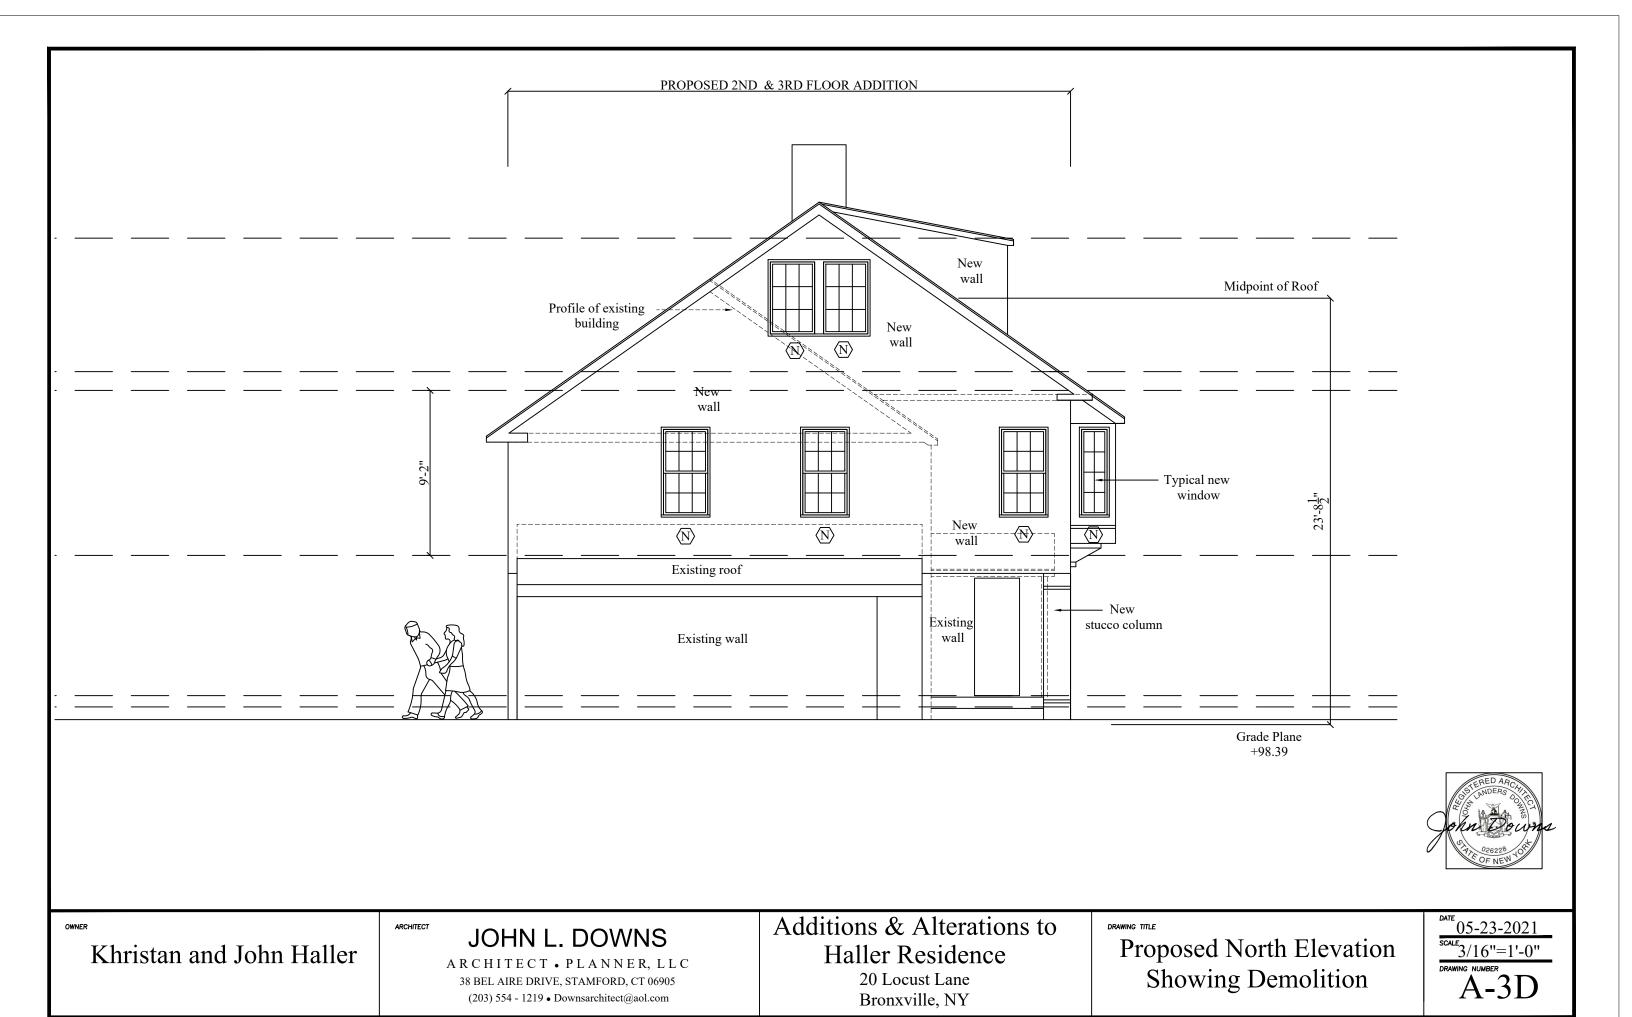

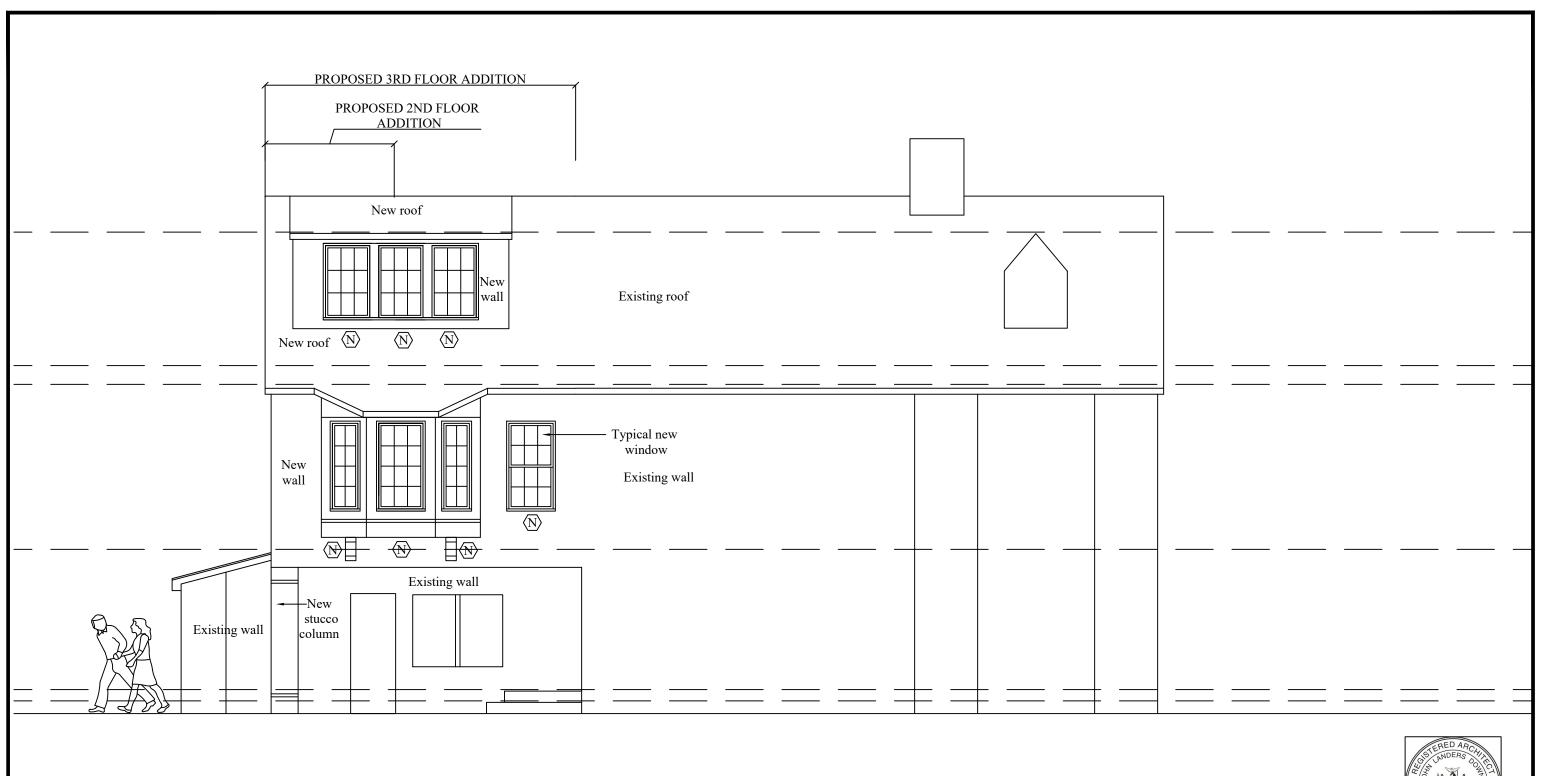



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Haller Residence
20 Locust Lane


Bronxville, NY

DRAWING TITLE

Proposed West Elevation

 $\frac{05-23-2021}{\frac{3}{1}6"=1'-0"}$

RAWING NUMBER A-4

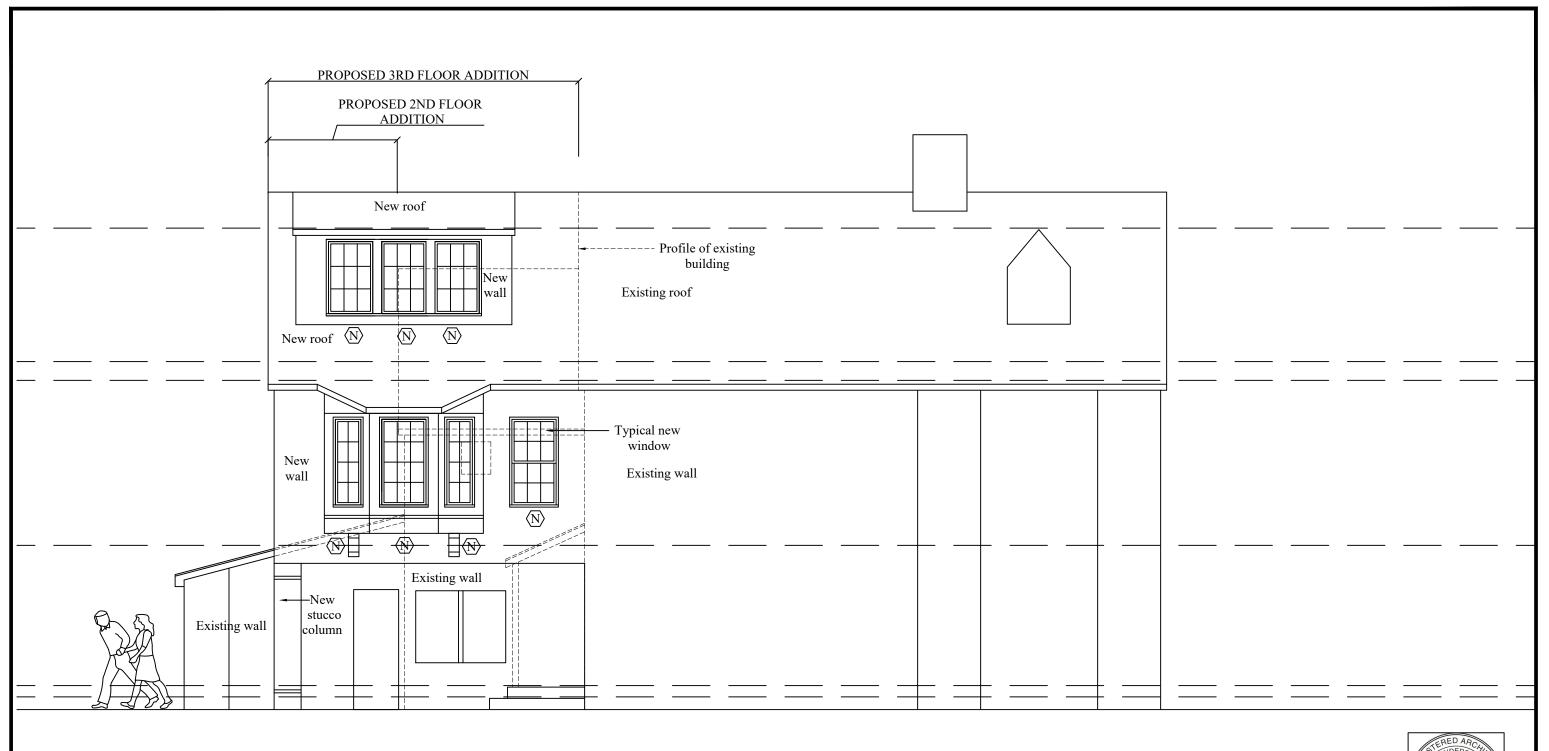



Khristan and John Haller

JOHN L. DOWNS


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Additions & Alterations to
Haller Residence
20 Locust Lane

Bronxville, NY

DAWING TITLE

Proposed West Elevation Showing Demolition 05-23-2021
SCALE 3/16"=1'-0"
DRAWING NUMBER

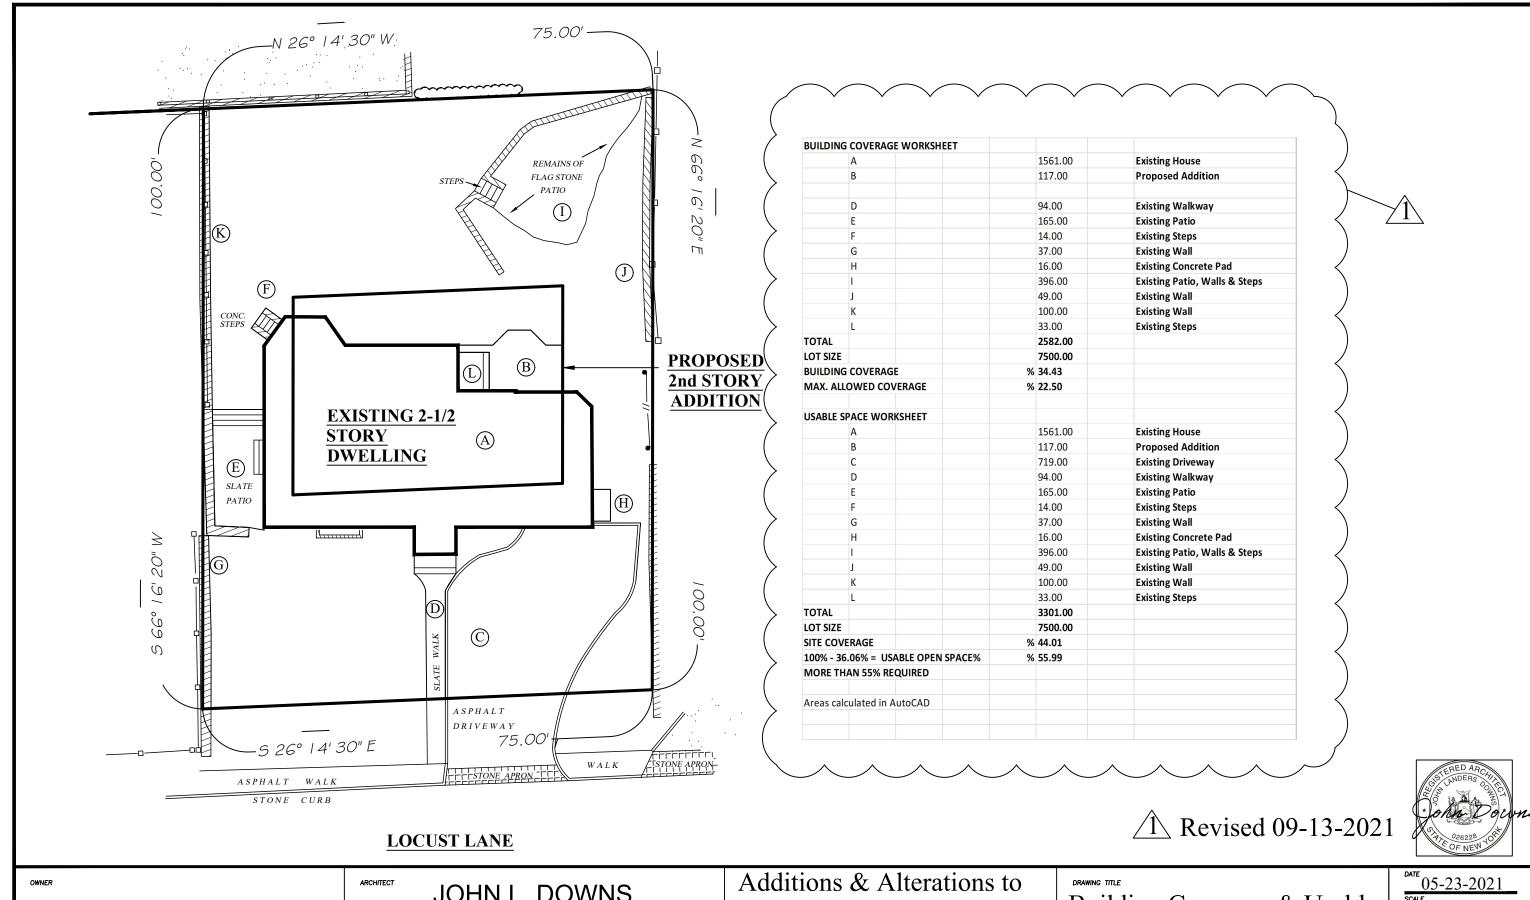

JOHN L. DOWNS


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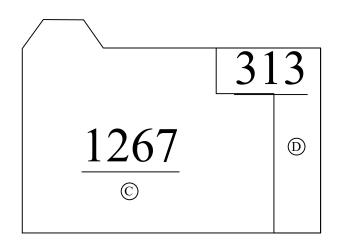
Haller Residence

20 Locust Lane Bronxville, NY


Building Coverage & Usable Open Space Calculations

05-23-2021 SCALE



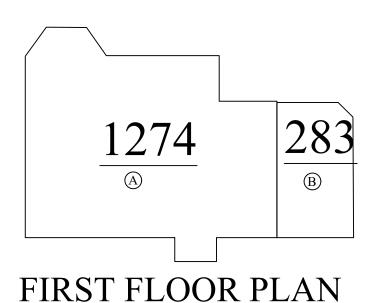

SECOND FLOOR PLAN

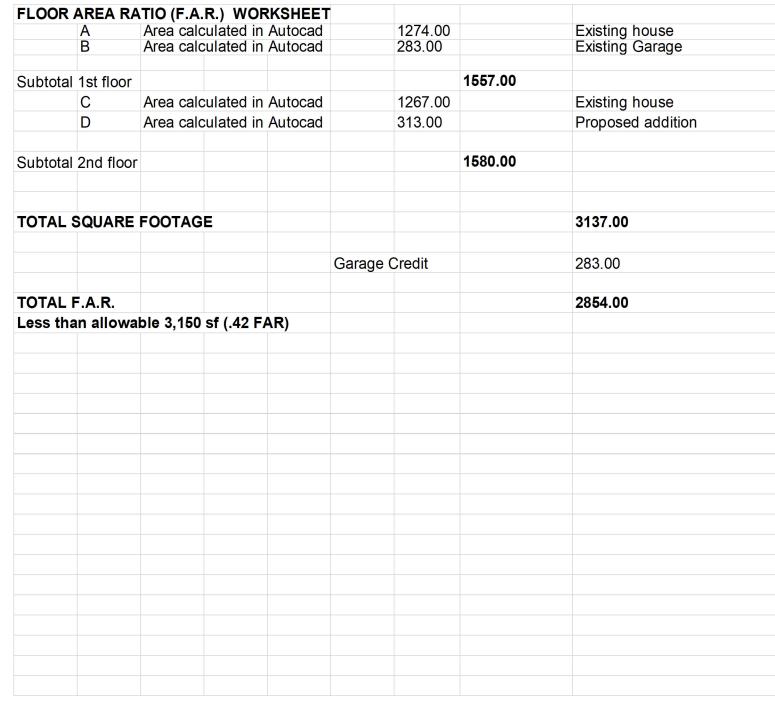

EXISTING FAR SQ FT= 2,541



OWNER

Khristan and John Haller

RCHITECT

JOHN L. DOWNS

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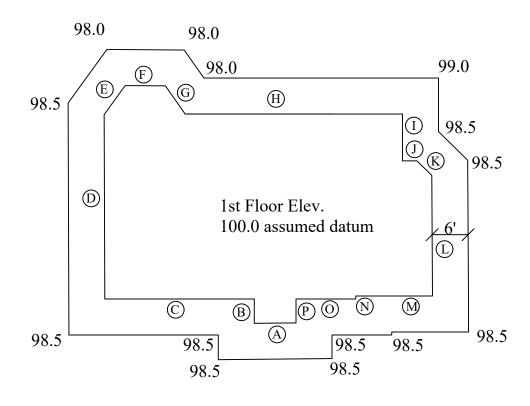
Additions & Alterations to Haller Residence 20 Locust Lane Bronxville, NY

DRAWING TITLE

Floor Area Ratio Calculations

05-23-2021 SCALE

DRAWING NUMBER



	LOWEST or AVERAGE ELEVATION		WALL LENGTH	WEIGHTED PERIMETER
A	98.5	Χ	7.00	689.50
В	98.5		4.00	394.00
С	98.5		25.00	2462.50
D	98.5		30.75	3028.88
E	98.5		6.00	591.00
F	98		6.75	661.50
G	98		6.00	588.00
H	98		36.25	3552.50
	99		7.75	767.25
J	98.5		2.50	246.25
K	98.5		3.50	344.75
L	98.5		20.00	1970.00
M	98.5		12.75	1255.88
N	98.5		0.50	49.25
0	98.5		10.00	985.00
P	98.5		4.00	394.00
SUBTOTAL MAIN HOUSE			182.75	17980.25
GRADE PLANE ELEVATI	ON = TOTAL WEIGHTED PERIMETER / TO	OTAL	WALL LENGTH =	98.39
First floor elevation 100.00				
Grade plane elevation is les Finished grade is not more	ss than 6 feet below first floor elevation. than 6 feet below first floor elevation for mor			g perimeter.
Grade plane elevation is les Finished grade is not more Finished grade is not more	ss than 6 feet below first floor elevation. than 6 feet below first floor elevation for mor than 12 feet below first floor elevation at any	point.		g perimeter.
Grade plane elevation is les Finished grade is not more Finished grade is not more	ss than 6 feet below first floor elevation. than 6 feet below first floor elevation for mor	point.		g perimeter.
Grade plane elevation is les Finished grade is not more Finished grade is not more	ss than 6 feet below first floor elevation. than 6 feet below first floor elevation for mor than 12 feet below first floor elevation at any	point.		g perimeter.
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Khristan and John Haller

JOHN L. DOWNS

A R C H I T E C T • P L A N N E R, L L C 38 BEL AIRE DRIVE, STAMFORD, CT 06905 (203) 554 - 1219 • Downsarchitect@aol.com Additions & Alterations to Haller Residence 20 Locust Lane Bronxville, NY

DRAWING TITLE

Grade Plane Calculations


05-23-2021 SCALE

DRAWING NUMBER


Third floor square footage above 5' in height is less than $\frac{1}{2}$ the square footage of the second floor below.

Dormer length does not exceed 30% of overall roof length

Therefore third floor is not a story and is excluded from FAR calculations.

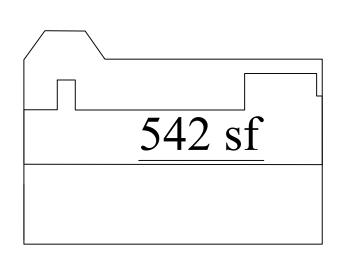

Third Floor Plan

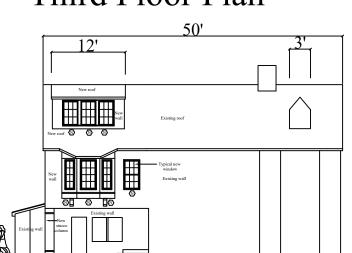

1580 sf

Second Floor Plan

West Elevation



WNER

Khristan and John Haller

ARCHITECT

JOHN L. DOWNS

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DRAWING TITLE

 $\frac{1}{2}$ Story Calculations

05-23-2021 SCALE

DRAWING NUMBER

-4